

# Exhibit 3.16 Utility Plan

The utility plan is noted on the site plan.

Exhibit 3.17 Site Plan

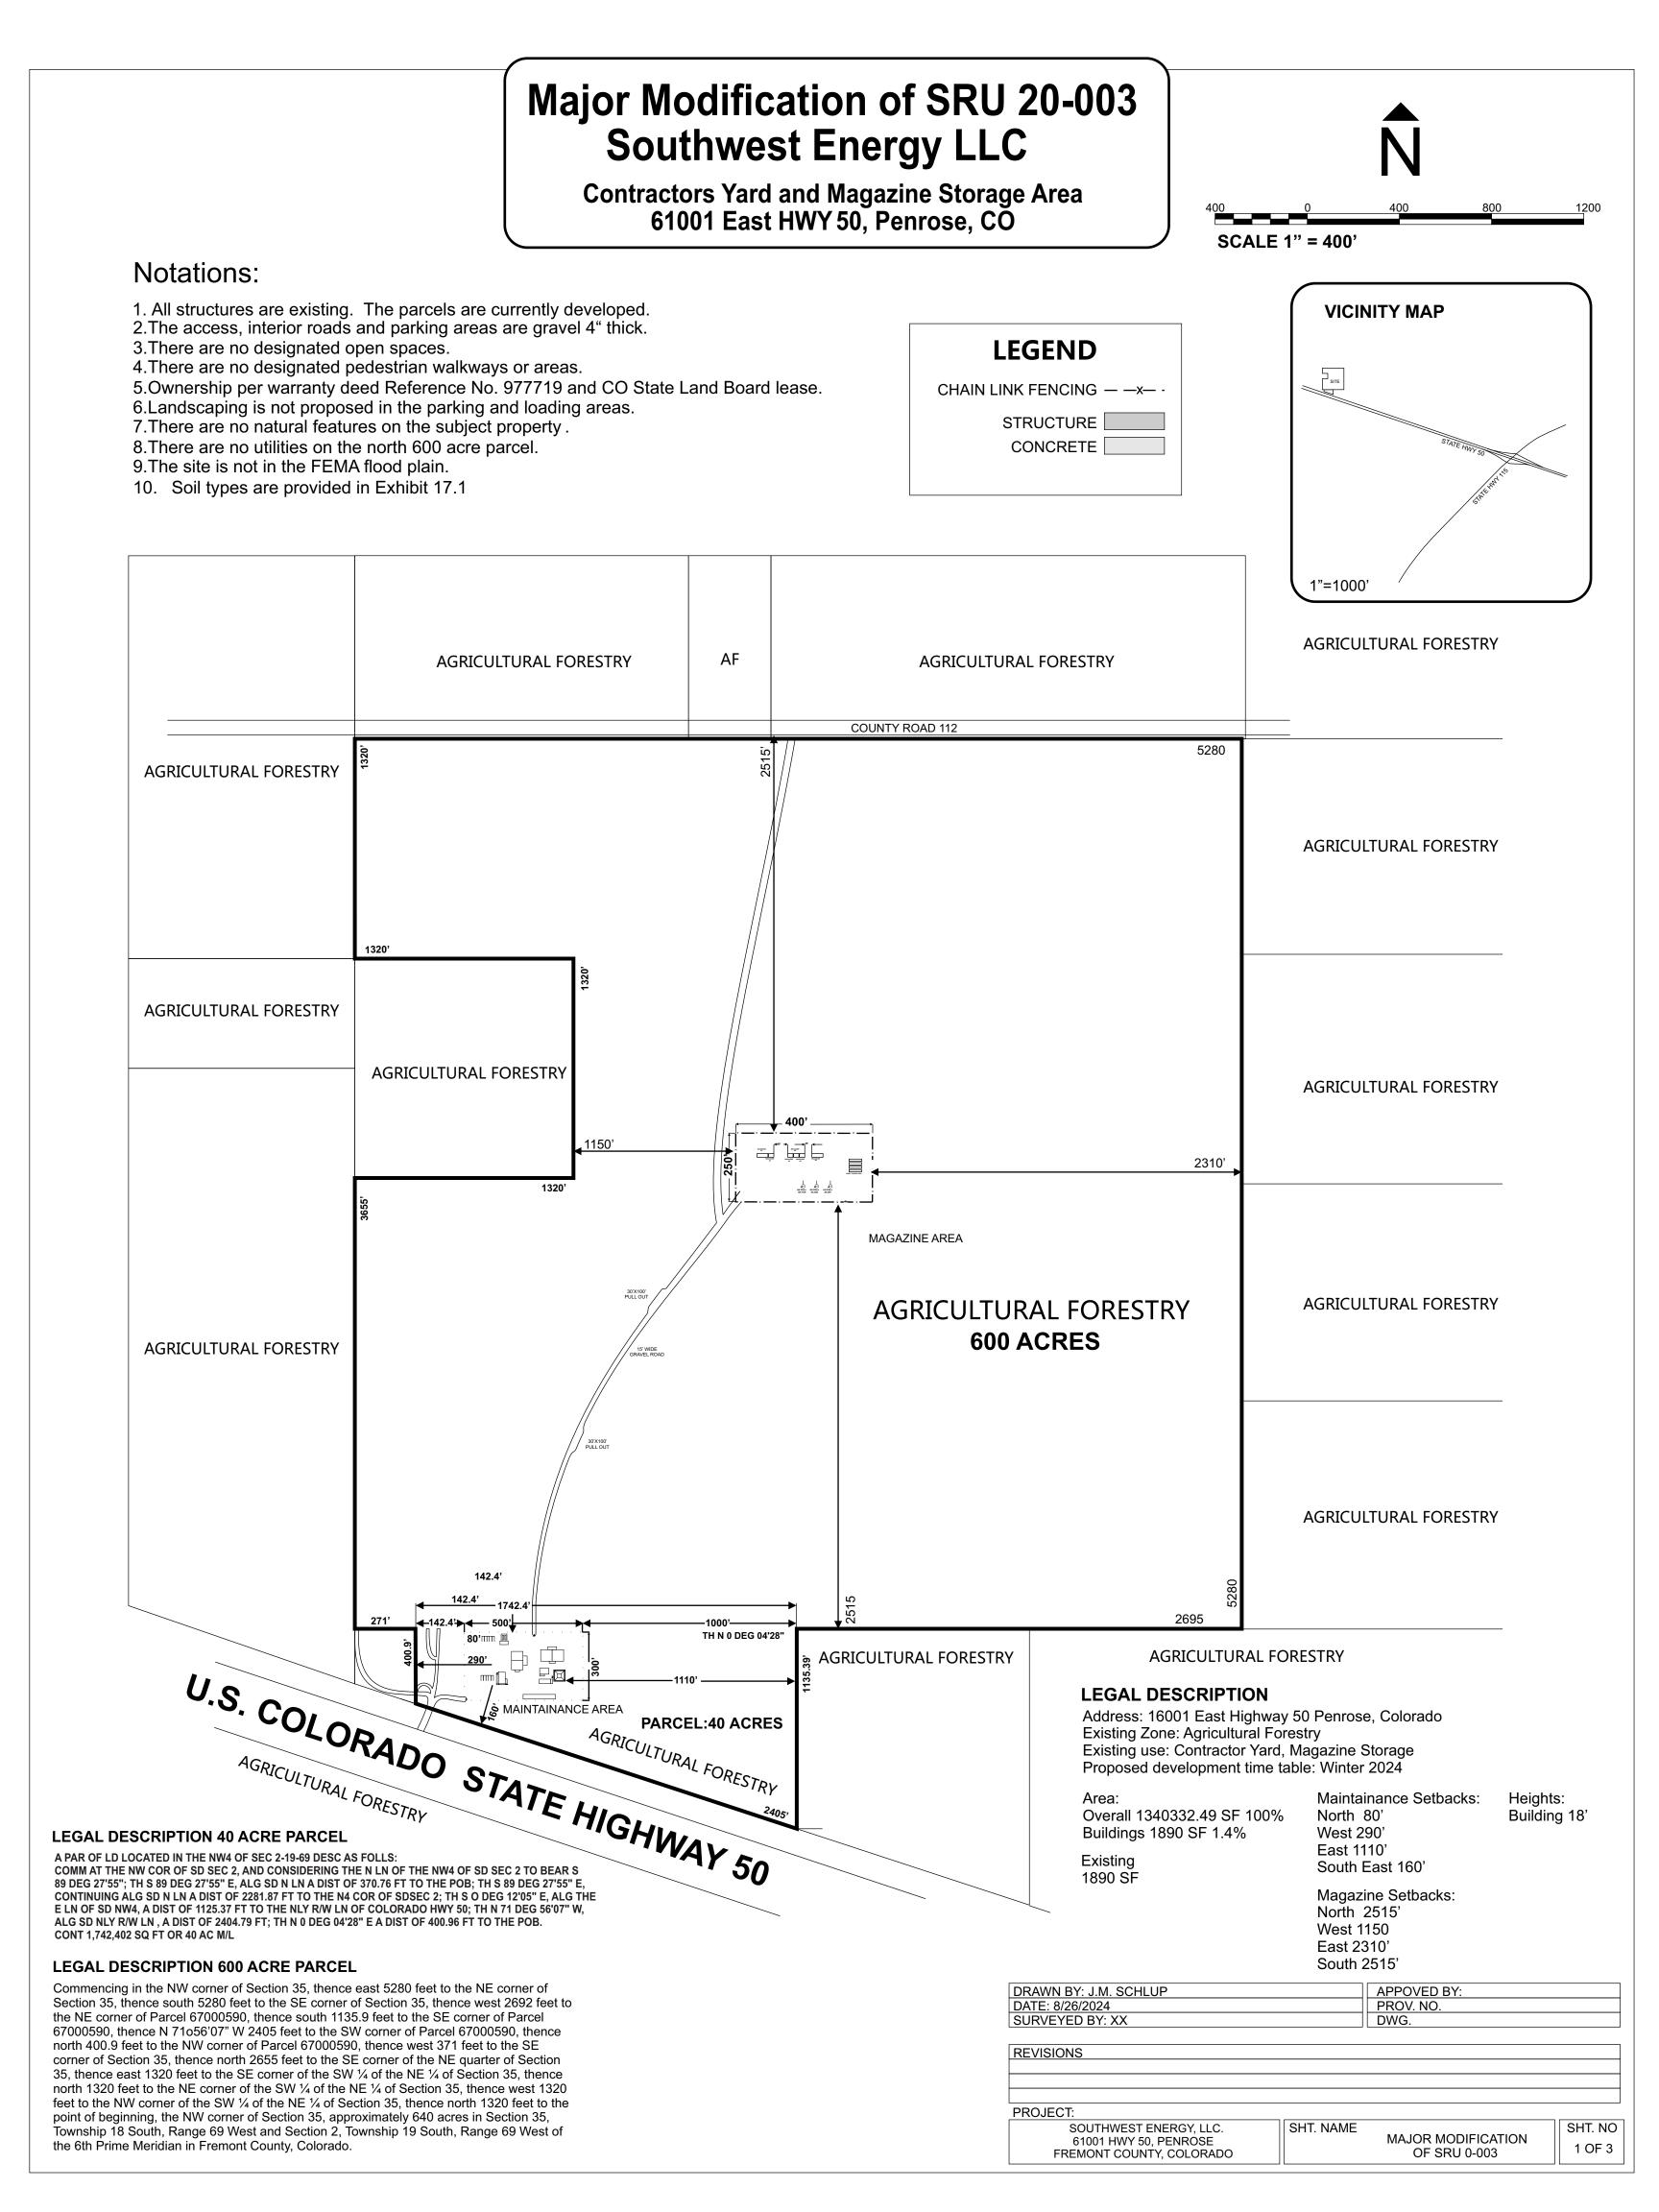

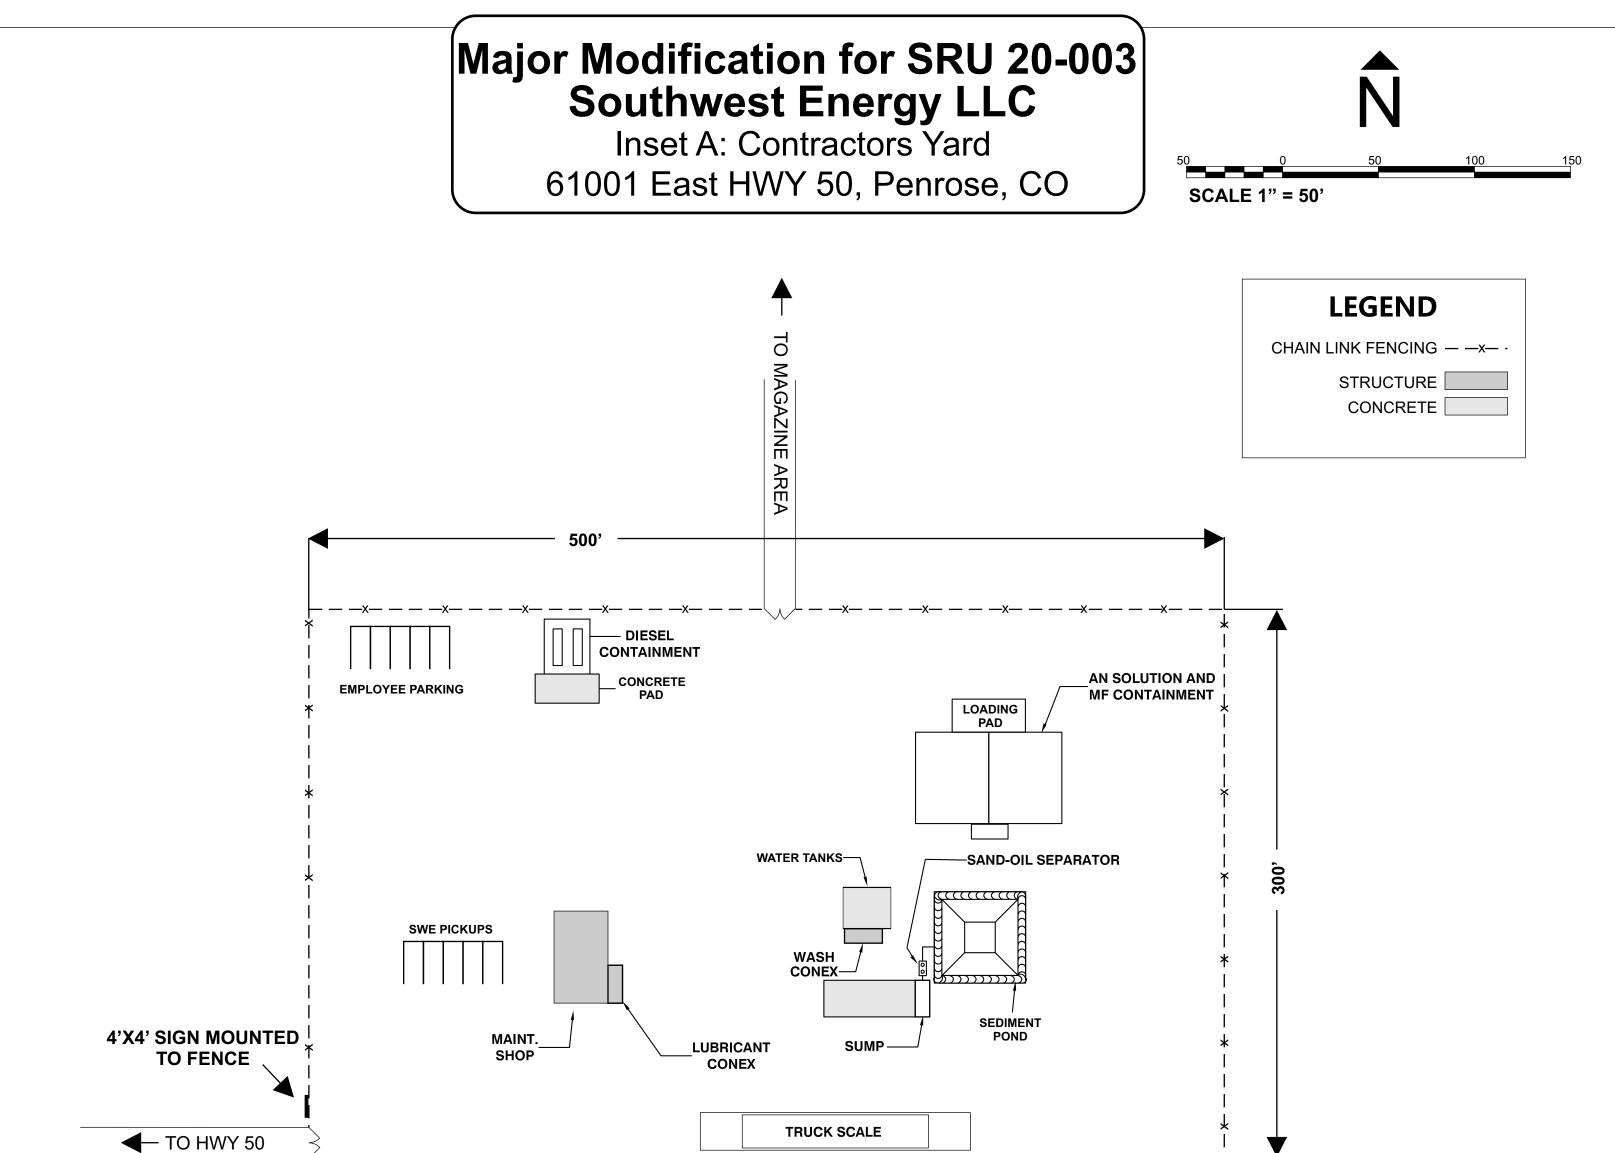


# **NOTATIONS:**

1. All structures are existing. The parcels are currently developed.

- 2. The access, interior roads and parking areas are gravel 4" thick.
- 3. There are no designated open spaces.
- 4. There are no designated pedestrian walkways or areas.
- 5. Ownership per warranty deed Reference No. 977719 and CO State Land Board lease.
- 6. Landscaping is not proposed in the parking and loading areas.
- 7. There are no natural features on the subject property.
- 8. There are no utilities on the north 600 acre parcel.
- 9. The site is not in the FEMA flood plain.
- 10. Soil types are provided in Exhibit 17.1

### STANDARD **PARKING DETAIL**

<del>-X</del>

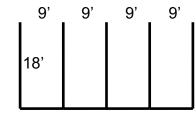

1"=20'

Number of Parking Spots

12	Standard 9'x18'		
8	Truck 12'x44'		
4	DROP TRAILER 12'x44'		

## **PROPERTY DESCRIPTION**

Address: 61001 East Highway 50 Penrose, Colorado Existing Zone: Agricultural Forestry Existing use: Contractor Yard, Magazine Storage Proposed development time table: Winter 2024

Area: Overall 1340332.49 SF 100% Buildings 1890 SF 1.4%

Existing 1890 SF

Maintainance Setbacks: North 80' West 290' East 1110' South East 160'


Heights: Building 18'

Magazine Setbacks: North 2515' West 1150 East 2310' South 2515'

# **EXISTING STRUCTURES TABLE**

MAINT.SHOP	25'X50' 1250 SF, BUILDING HEIGHT 21'
OFFICE CONEX	100'X50' 5000 SF, BUILDING HEIGHT 10'
WASH CONEX	60'X40' 2400 SF, BUILDING HEIGHT 10'
LUBRICANT CONEX	30'X20' 600 SF, BUILDING HEIGHT 10'

DRAWN BY: J.M. SCHLUP		APPOVED BY:	
DATE: 8/26/2024		PROV. NO.	
SURVEYED BY: XX		DWG.	
REVISIONS			
PROJECT:			
SOUTHWEST ENERGY,LLC.	SHT. NAME	MAJOR MODIFICATION	SHT. NO
61001 HWY 50, PENROSE, CO		OF SRU 0-003	2 OF 3
,,,			

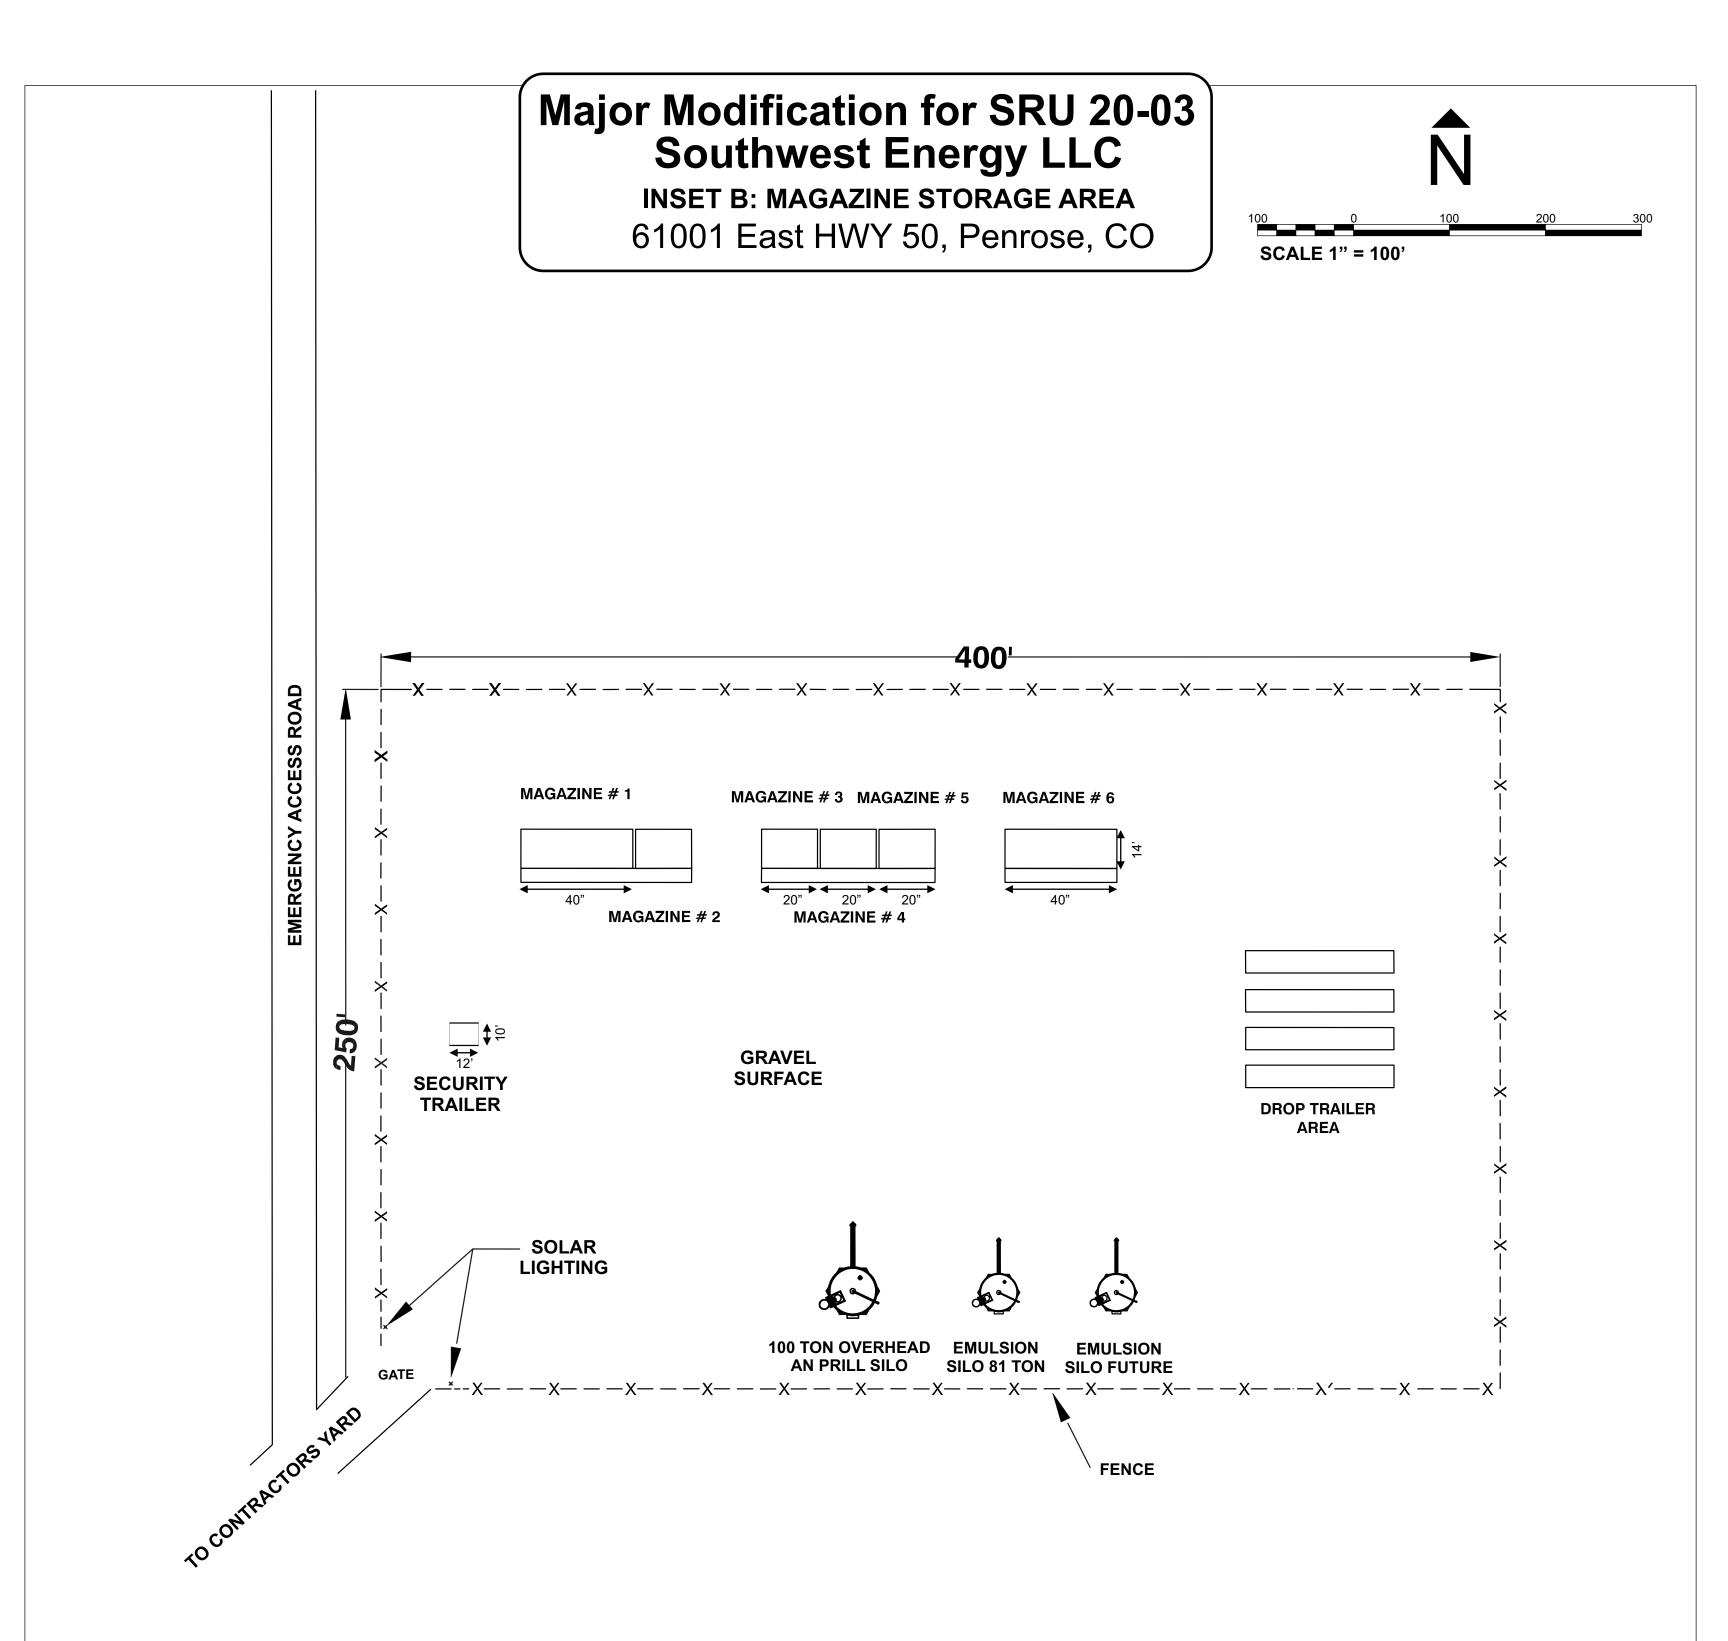

### Number of Parking Spots

12	Standard 9'x18'		
8	Truck 12'x44'		
4	DROP TRAILER 12'x44'		

### LEGAL DESCRIPTION


Address: 16001 East Highway 50 Penrose, Colorado
Existing Zone: Agricultural Forestry
Existing use: Contractor Yard, Magazine Storage
Proposed development time table: Winter 2024

Area:	Maintainance Setbacks:	Heights:
Overall 1340332.49 SF 100%	North 80'	Building 18'
Buildings 1890 SF 1.4%	West 290'	-
	East 1110'	
Existing 1890 SF	South East 160'	
	Magazine Setbacks:	
	North 2515'	
	West 1150	
	East 2310'	
	South 2515'	

PPOVED BY:
ROV. NO.
NG.

PROJECT:

SOUTHWEST ENERGY, LLC. INDUSTRIAL ZONE 61001 HWY 50, PENROSE FREMONT COUNTY, COLORADO	SHT. NAME MAJOR MODIFICATION OF SRU 0-003	SHT. NO 3 OF 3

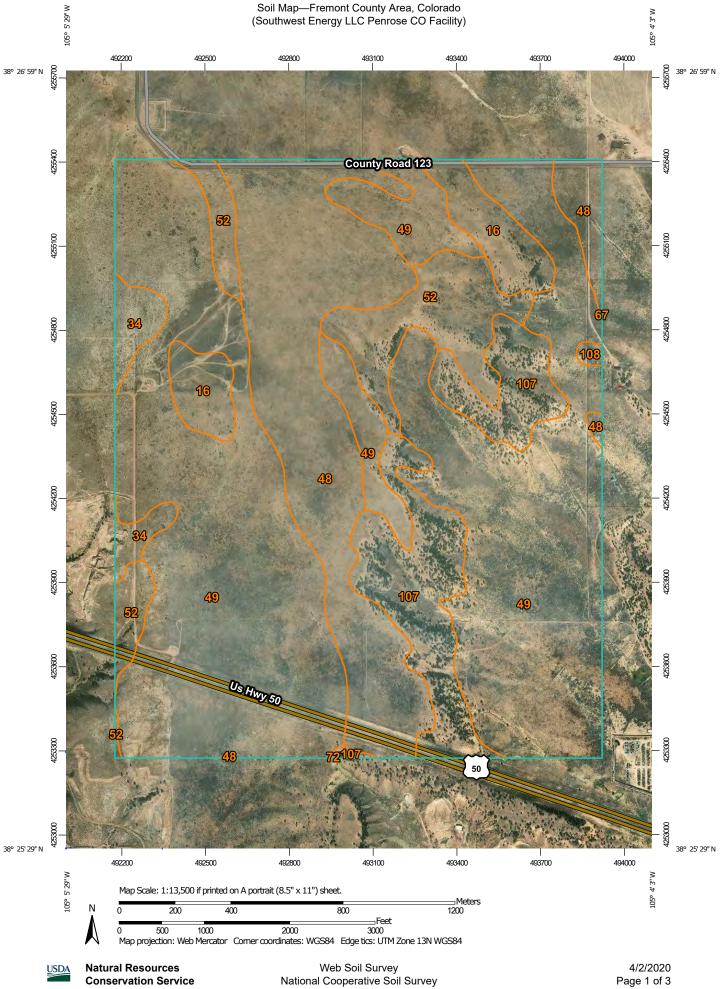

**Conservation Service** 

MAP LEGEND		MAP INFORMATION	
Area of Interest (AOI) Area of Interest (AOI) Soils Soil Map Unit Polygons Soil Map Unit Lines	<ul> <li>Spoil Area</li> <li>Stony Spot</li> <li>Very Stony Spot</li> <li>Wet Spot</li> </ul>	The soil surveys that comprise your AOI were mapped at 1:24,000. Please rely on the bar scale on each map sheet for map measurements. Source of Map: Natural Resources Conservation Service	
Soil Map Unit Points Special Point Features Blowout Borrow Pit Clay Spot	<ul> <li>△ Other</li> <li>✓ Special Line Features</li> <li>✓ Water Features</li> <li>✓ Streams and Canals</li> <li>Transportation</li> </ul>	Web Soil Survey URL: Coordinate System: Web Mercator (EPSG:3857) Maps from the Web Soil Survey are based on the Web Mercator projection, which preserves direction and shape but distorts distance and area. A projection that preserves area, such as the Albers equal-area conic projection, should be used if more accurate calculations of distance or area are required.	
Closed Depression Gravel Pit Gravelly Spot	<ul> <li>Rails</li> <li>Interstate Highways</li> <li>US Routes</li> <li>Major Roads</li> <li>Local Roads</li> </ul>	This product is generated from the USDA-NRCS certified data as of the version date(s) listed below. Soil Survey Area: Fremont County Area, Colorado Survey Area Data: Version 17, Sep 13, 2019 Soil map units are labeled (as space allows) for map scales	
<ul> <li>▲ Lava Flow</li> <li>▲ Marsh or swamp</li> <li>☆ Mine or Quarry</li> </ul>	Background Aerial Photography	1:50,000 or larger. Date(s) aerial images were photographed: Nov 19, 2013—Nov 15, 2017 The orthophoto or other base map on which the soil lines were	
<ul> <li>Miscellaneous Water</li> <li>Perennial Water</li> <li>Rock Outcrop</li> <li>Saline Spot</li> </ul>		compiled and digitized probably differs from the background imagery displayed on these maps. As a result, some minor shifting of map unit boundaries may be evident.	
<ul> <li>Sandy Spot</li> <li>Severely Eroded Spot</li> <li>Sinkhole</li> <li>Slide or Slip</li> <li>Sodic Spot</li> </ul>			

USDA

# Map Unit Legend

Map Unit Symbol	Map Unit Name	Acres in AOI	Percent of AOI
16	Cascajo very gravelly sandy loam, 10 to 40 percent slopes	39.0	4.2%
34	Fort loam, 1 to 3 percent slopes	17.8	1.9%
48	Kim loam, 0 to 3 percent slopes	184.1	19.9%
49	Kim loam, 3 to 8 percent slopes	520.4	56.3%
52	Kim-Cascajo complex, 2 to 15 percent slopes	69.6	7.5%
67	Manvel silty clay loam, saline	0.0	0.0%
72	Midway-Cascajo complex, 10 to 40 percent slopes	0.0	0.0%
107	Shingle very cobbly sandy loam, 10 to 40 percent slopes	91.3	9.9%
108	Shingle loam, 3 to 20 percent slopes	1.7	0.2%
Totals for Area of Interest		923.8	100.0%