PROJECT TEAM

CLIENT REPRESENTATIVE
COMPANY: SMARTLINK, LLC 10 CHURCH CIRCLE

CITY, STATE, ZIP: CONTACT: ANNAPOLIS, MD 2140

JUAN ANDRADE@SMARTLINKGROUP.COM

PROJECT OWNER

AT&T

1355 WEST UNIVERSITY DRIVE MESA, AZ 85201-5419

PROFESSIONAL OF RECORD
COMPANY: TELCYTE INFRASTRUCTURE SERVICES
ADDRESS: 3450 N. HIGLEY ROAD - SUITE 102
CITY, STATE, ZIP: MESA, AZ 85216

CONTACT: CHRIS WOLFE

(833) 835-2983 CWOLFE@TELCYTE.COM

PROPERTY OWNER

NAME: STATE OF COLORADO

ADDRESS: CITY, STATE, ZIP:

AT&T TOWERS 1355 WEST UNIVERSITY DRIVE ADDRESS:

CITY, STATE, ZIP: MESA AZ 85201-5419 MARICELA CITY (CO-LO PROCESS MANAGER) CONTACT

E-MAIL MC5293@ATT.COM



COLO6032 **MEDIAN POINT**

24860 HIGHWAY 115 PENROSE, CO 81240

LTE 1C RRH SWAP PTN: 3755A1CJWK, 5G NR RRH SWAP PTN: 3755A1CLBR

LTE RRH SWAP PTN: 3755A1CJLH

JOB ID:

WSANM0042609, WSANM0042425, WSANM0042326

FA: 10114750 USID: 87013

SHEET	DESCRIPTION		
T-1	TITLE SHEET		
A-1	SITE PLAN		
A-1.1	ENLARGED SITE PLAN		
A-2	EQUIPMENTS - EXISTING & NEW		
A-3	ANTENNA LAYOUTS & SCHEDULES		
A-4	ELEVATIONS - EXISTING & NEW		
E-1	GROUNDING PLANS		
	DRAWINGS HAVE BEEN FORMATTED FOR 22"X34" CONTRACTOR TO REFERENCE PACKAGE "B" FOR SCHEMATICS, WIRING DIAGRAMS AND DETAILS.		

GENERAL NOTES

DO NOT SCALE DRAWINGS

CONTRACTOR SHALL VERIFY ALL PLANS AND EXISTING DIMENSIONS AND CONDITIONS ON THE JOE SITE AND SHALL IMMEDIATELY NOTIFY THE ARCHITECTER/GINEER IN WITTING OF ANY DISCREPANCIES BEFORE PROCEEDING WITH THE WORK OR BE RESPONSIBLE FOR SAME.

THE FACILITY IS UNMANNED AND NOT FOR HUMAN HABITATION. A TECHNICIAN WILL VISIT THE SITE AS REQUIRED FOR ROUTINE MAINTENANCE. THE PROJECT WILL NOT RESULT IN ANY SIGNIFICANT DISTURBANCE OR EFFECT ON DRAINAGE. TO ASSANTARY SEWER SERVICE, POTABLE WATER, OR TRASH DISPOSAL IS REQUIRED AND NO COMMERCIAL SIGNAGE IS PROPOSED.

VICINITY MAP 0 9400e 150 O NOT TO SCALE

DRIVING DIRECTIONS

FROM AT&T OFFICE (DENVER INTERNATIONAL AIRPORT 8500 PENA BLVD, DENVER, CO 80249):

HEAD WEST ON E 78TH AVE CONNECTOR, MERGE ONTO PENA BLVD, TAKE EXIT 6A TOWARD 1-70 SOUTH, USE THE LEFT LANE TO TAKE THE DENVER INT'L AIRPORT RAMP (TOLL ROAD), MERGE ONTO E-470 SOUTH (TOLL ROAD 26.3 MILES) USE THE RIGHT 2 LANES TO TAKE EXIT 1A FOR INTERSTATE 25 SOUTH TOWARD COLORADO SPRINGS. ((6.8 MILES) MERGE ONTO 1-25 SOUTH (6.3.6 MILES) USE THE 25 SOUTH TOWARD COLORADO SPRINGS. ((6.8 MILES) MERGE ONTO 1-25 SOUTH (6.3.6 MILES) USE THE 25 MERGE ONTO 1-25 SOUTH (1.2.6 MILES) PASS GCC RIO GRANDE INC., SALT CANYON GYPSUM GUARRY ON YOUR RIGHT, ABOUT 0.5 MILE PAST THAT TURN RIGHT INTO LARGE DIRT TURN-OUT WITH CATTLE. FOLLOW DIRT ROAD UP TO TOWER.

SITE INFORMATION

LATITUDE: 38.52855 LONGITUDE: LAT /LONG TYPE: NAD 83 GROUND ELEVATION: --- MSL APN #:

AREA OF CONSTRUCTION: EXISTING

ZONING/JURISDICTION: STATE OF COLORADO

CURRENT ZONING

UNMANNED TELECOMMUNICATIONS FACILITY

FREMONT COUNTY

HANDICAP REQUIREMENTS: FACILITY IS UNMANNED AND NOT FOR HUMAN HABITATION, HANDICAPPED ACCESS NOT REQUIRED.

CODE COMPLIANCE

BUILDING CODE: INTERNATIONAL BUILDING CODE 2018 ELECTRICAL CODE: NATIONAL ELECTRICAL CODE 2017

GHTNING PROTECTION CODE: NEPA 780 - 2014, LIGHTNING PROTECTION SYSTEM

SUBCONTRACTOR'S WORK SHALL COMPLY WITH ALL APPLICABLE NATIONAL, STATE, AND LOCAL CODES AS ADOPTED BY THE LOCAL AUTHORITY HAVING JURISDICTION (AHJ) FOR THE LOCATION.
THE EDITION OF THE AHJ ADOPTED CODES AND STANDARDS IN EFFECT ON THE DATE OF CONTRAC WARD SHALL GOVERN THE DESIGN

FOR ANY CONFLICTS BETWEEN SECTIONS OF LISTED CODES AND STANDARDS REGARDING MATERIAL, METHODS OF CONSTRUCTION, OR OTHER REQUIREMENTS, THE MOST RESTRICTIVE REQUIREMENT SHALL GOVERN, WHERE THERE IS CONFLICT BETWEEN A GENERAL REQUIREMENT AND A SPECIFIC REQUIREMENT, THE SPECIFIC REQUIREMENT SHALL GOVERN.

RFDS DATA

DESIGN PACKAGE BASED ON RF DATA SHEET RFDS NAME: -

REVISION: — RFDS DATE: 04/22/2024

APPROVALS DATE: AT&T (CONST.): DATE: AT&T (SAM): DATE: LANDLORD: DATE: LANDLORD: DATE:

FIELD DATA SUMMARY YES ANTENNA SWAP NUMBER OF EXISTING COAX NUMBER OF EXISTING DC CABLE TRUNKS NUMBER OF EXISTING FIBER CABLE PAIRS 181' APPROX DISTANCE OF FIBER/COAX RUN PENDING FIBER PROVIDER PENDING CIRCUIT ID *CONTRACTOR TO FIELD VERIFY ALL QUANTITIES AND LENGTHS

PROJECT DESCRIPTION

THIS PROJECT WILL BE COMPRISED OF:

CHANGES ON THE EXISTING MONOPOLE:

REMOVE (2) DBXNH-6565B-R2M PANEL ANTENNAS

REMOVE ALL TMA:

REMOVE ALL RRHS

- REMOVE ALL NOKIA EQUIPMENT
- REMOVE ALL COAX

- REMOVE ALL COAX
 INSTALL (1) POST STAND-OFF ARM ON POS B1
 INSTALL (2) TPA65R-BU8DA-K ANTENNAS
 RETAIN (2) TPA65R-BU8DA-K ANTENNAS
 RETAIN (2) TPA65R-BU8DA-K ANTENNAS
 INSTALL (2) 4490 B5/B12A ON SXK1255394/2 B2B'S FOR P1 A/B TO BE INSTALLED ON (N) 10' PIPES
 INSTALL (2) 4490 B25/B66 ON SXK1255394/2 B2B'S TO BE SHARED W/ (2) 4478 B14'S FOR P3 A/B TO
 BE INSTALLED ON (N) 10' PIPES

CHANGES IN THE EXISTING AT&T EQUIPMENT ENCLOSURE AREA:

REMOVE ALL (E) RADIO CARDS

INSTALL (2) 6651 & (1) 6610 IN EXISTING LTE

- AC/DC SCOPE:
 DC POWER PLAN REVIEW:

 INSTALL (1) VERTIV 7100 w/ -58V CONVERSION KIT

 INSTALL (6) VERTV C49:69 -2000P3 CONVERTERS

 INSTALL (1) COMMSODPE 48V TO 58 VDC INDOOR CONV SYSTEM 26 BREAKERS (NEQ.57288)

 INSTALL BREAKERS AS NEEDED PER ATT-CEM-18002

BATTERY CHECK:
• RETAIN (20) EXISTING 170 BATTERIES (5) STRINGS TOTAL

HVAC UNITS:

NO WORK - INDOOR EQUIPMENT

JURISDICTIONAL APPROVAL



1355 WEST UNIVERSITY DRIVE MESA AZ 85201-5419

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8767 E, VIA DE VENTURA SUITE 200 SCOTTSDALE, AZ 85258



MESA, AZ 85215



0	05/20/24	PRELIMINARY
REV.	DATE	REVISION DESCRIPTION

THE CONTRACTOR SHALL INSTALL ALL EQUIPMENT AND THE CONTRACTOR SHALL INSTALL ALL EQUIPMENT AND MATERIALS IN ACCORDANCE WITH MANUFACTURES RECOMMENDATIONS AND SPEC'S, UNLESS SPECIFICALLY STATED OTHERWISE, THE MANUFACTURES EQUIPMENT INSTALLATION SPEC'S SHALL ALWAYS BE VERIFIED BY THE CONTRACTOR BEFORE INSTALLATION


COLO6032 MEDIAN POINT 24860 HIGHWAY 115 PENROSE, CO 81240 FREMONT

DRAWN BY:	CHECKED BY:	
JM	CM	
SHEET TITLE:		

SHEET

TITLE

SHEET NUMBER:

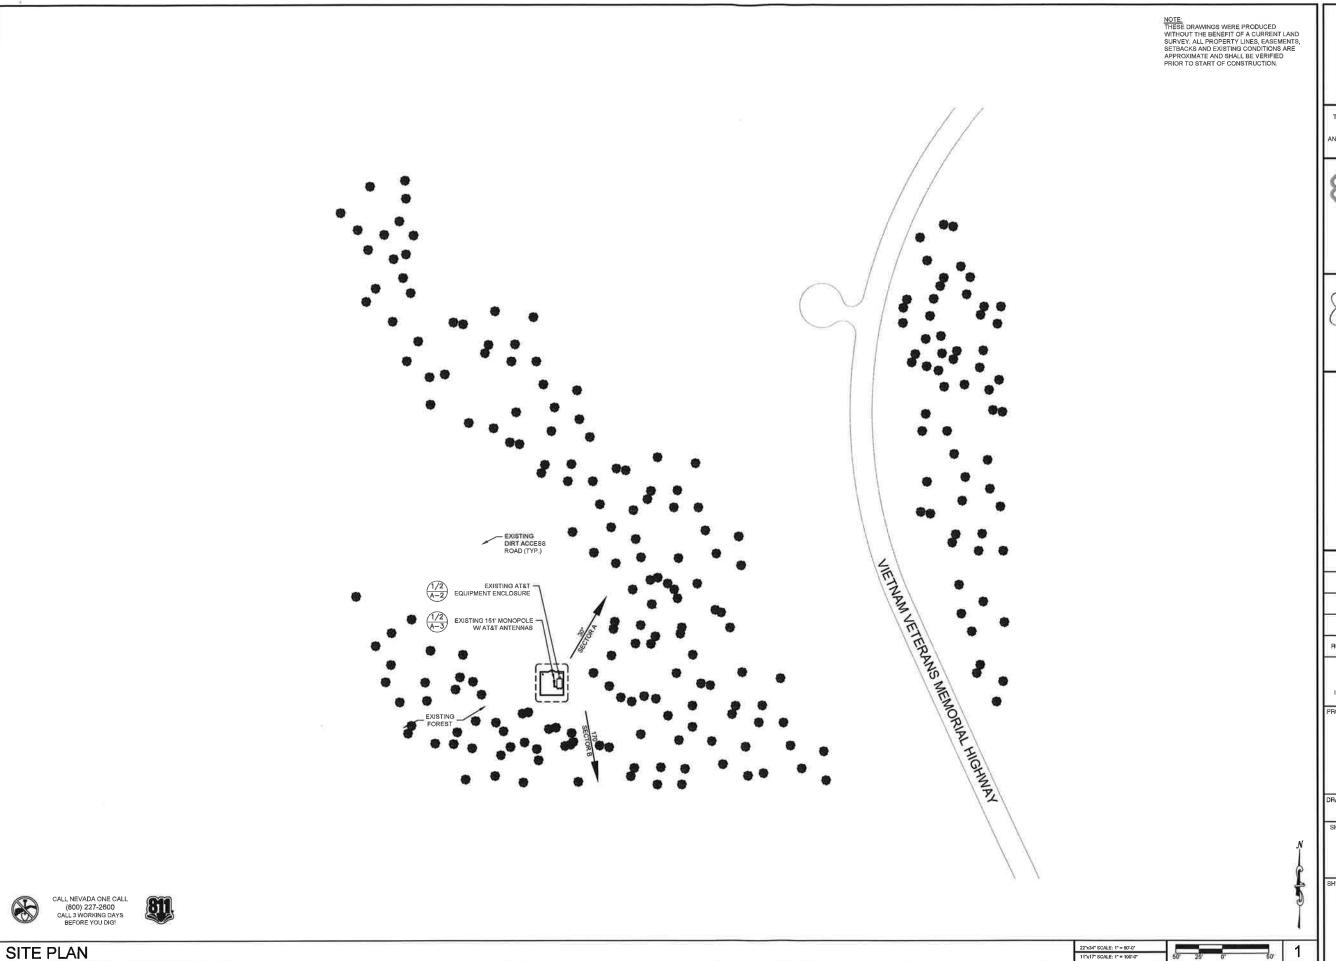



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TELCYTE
INFBASTRUCTURE SERVICES
3450 N HIGLEY RD - SUITE 102,
MESA, AZ 85215



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PROJECT INFORMATION:

COLO6032 MEDIAN POINT 24860 HIGHWAY 115 PENROSE, CO 81240 FREMONT

DRAWN BY:

JM

CHECKED BY:

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SHEET TITLE:

SITE


PLAN

SHEET NUMBER

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INFRASTBURTURE SERVIRES 3450 N HIGLEY RD - SUITE 102, MESA, AZ 85215



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١	0	05/20/24	PRELIMINARY
١	REV	DATE	REVISION DESCRIPTION
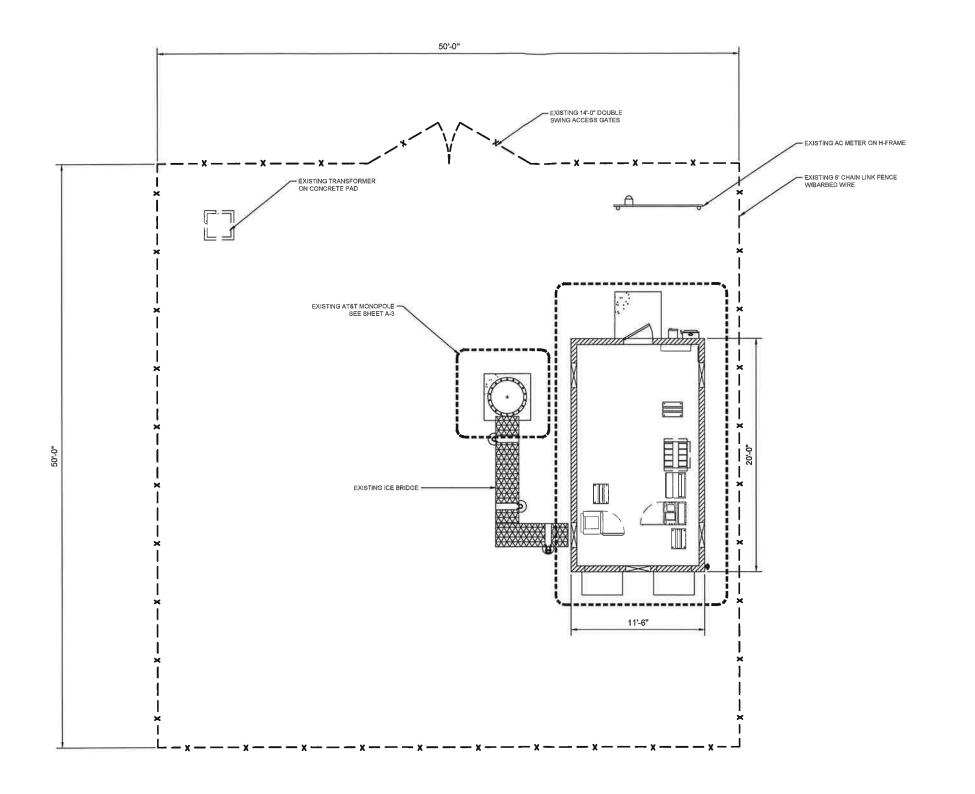
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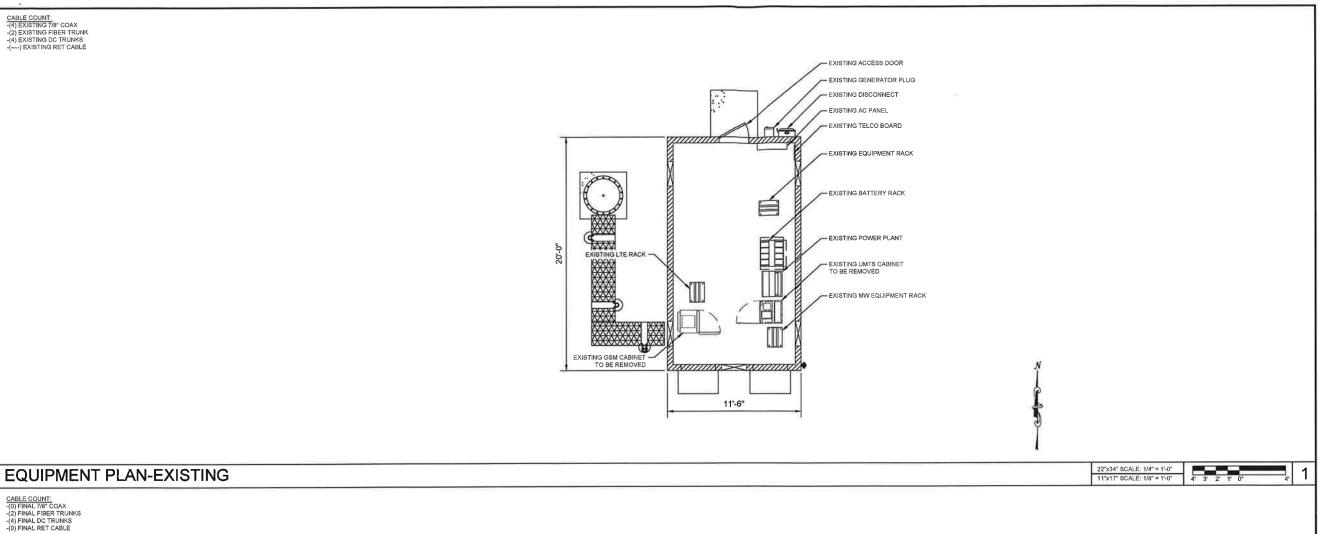
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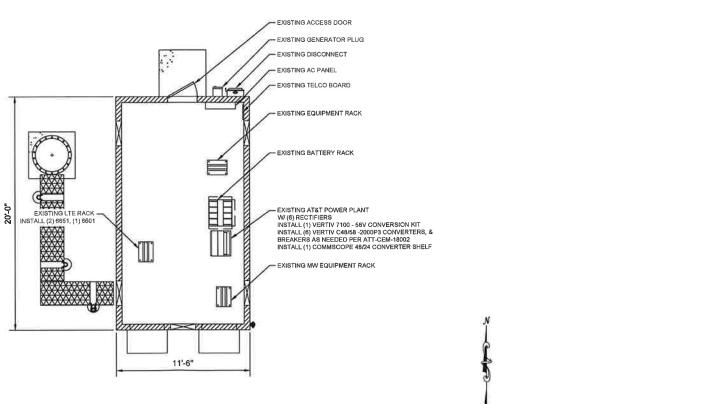
> ENLARGED SITE PLAN

ENLARGED SITE PLAN

22"x34" SCALE: 1/4" = 1'-0" 11"x17" SCALE: 1/8" = 1'-0"



22'x34" SCALE: 1/4" = 1'-0" 11"x17" SCALE: 1/6" = 1'-0" 4" 3" 2" 1" 0"





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3450 N HIGLEY RD - SUITE 102, MESA, AZ 85215



PRELIMINARY DATE REVISION DESCRIPTION REV.

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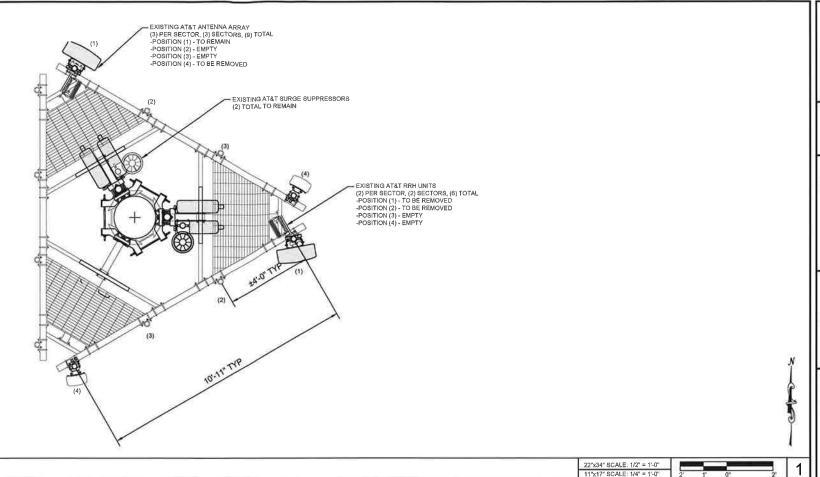
COLO6032 **MEDIAN POINT** 24860 HIGHWAY 115 PENROSE, CO 81240 FREMONT


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SHEET TITLE:

EQUIPMENT & ANTENNA LAYOUTS

SHEET NUMBER:



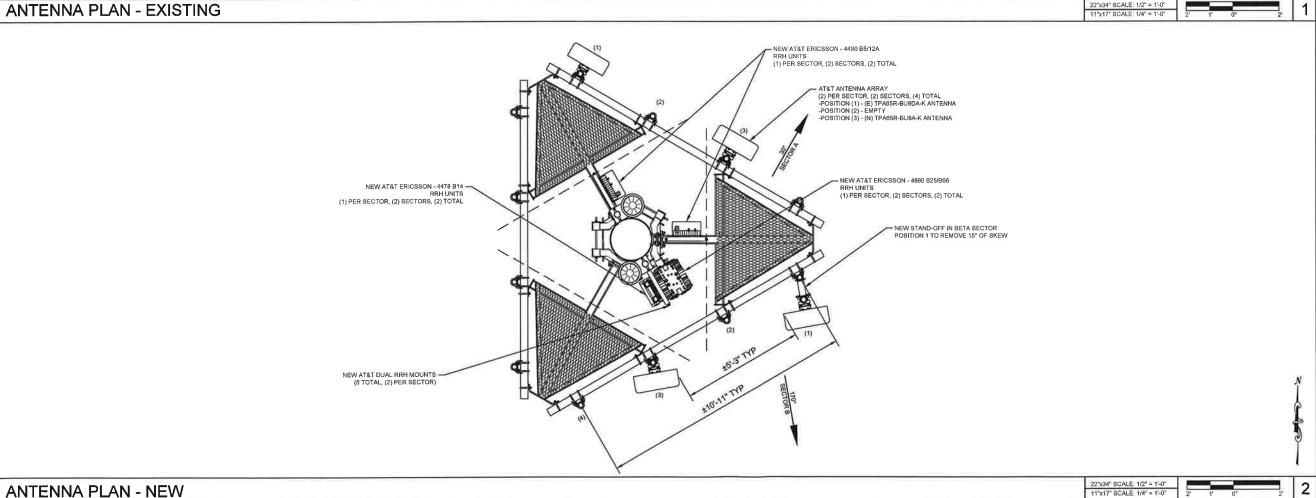

ANTENNA PLAN - NEW



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INFRASTRUCTURE SERVICES 3450 N HIGLEY RD - SUITE 102, MESA, AZ 85215



PRELIMINARY REV. DATE REVISION DESCRIPTION

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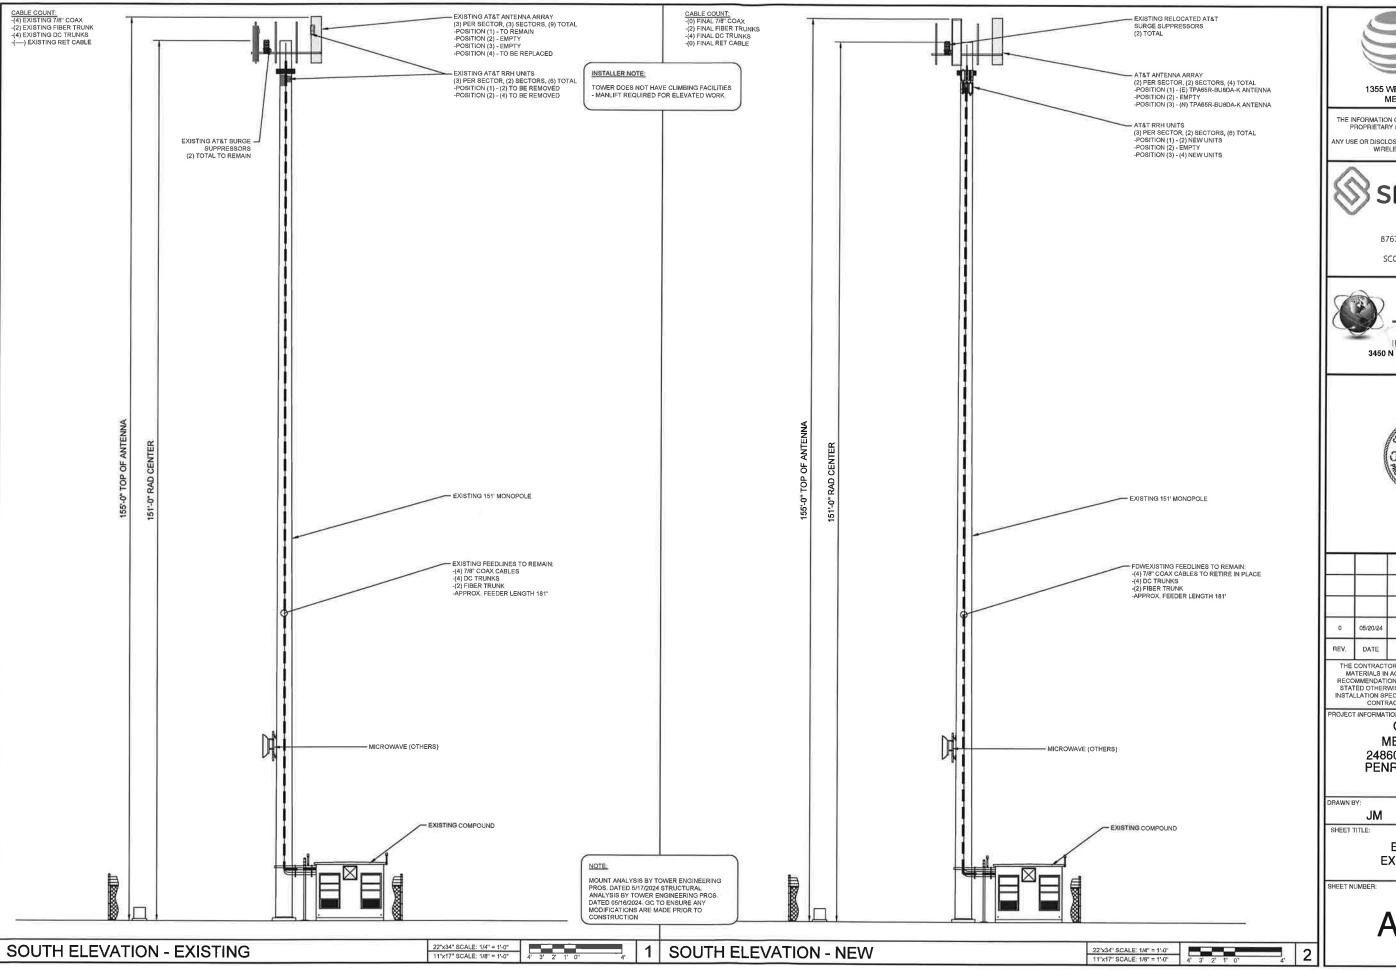
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DRAWN BY:

CHECKED BY: CM

SHEET TITLE:

ANTENNA PLANS & SCHEDULES





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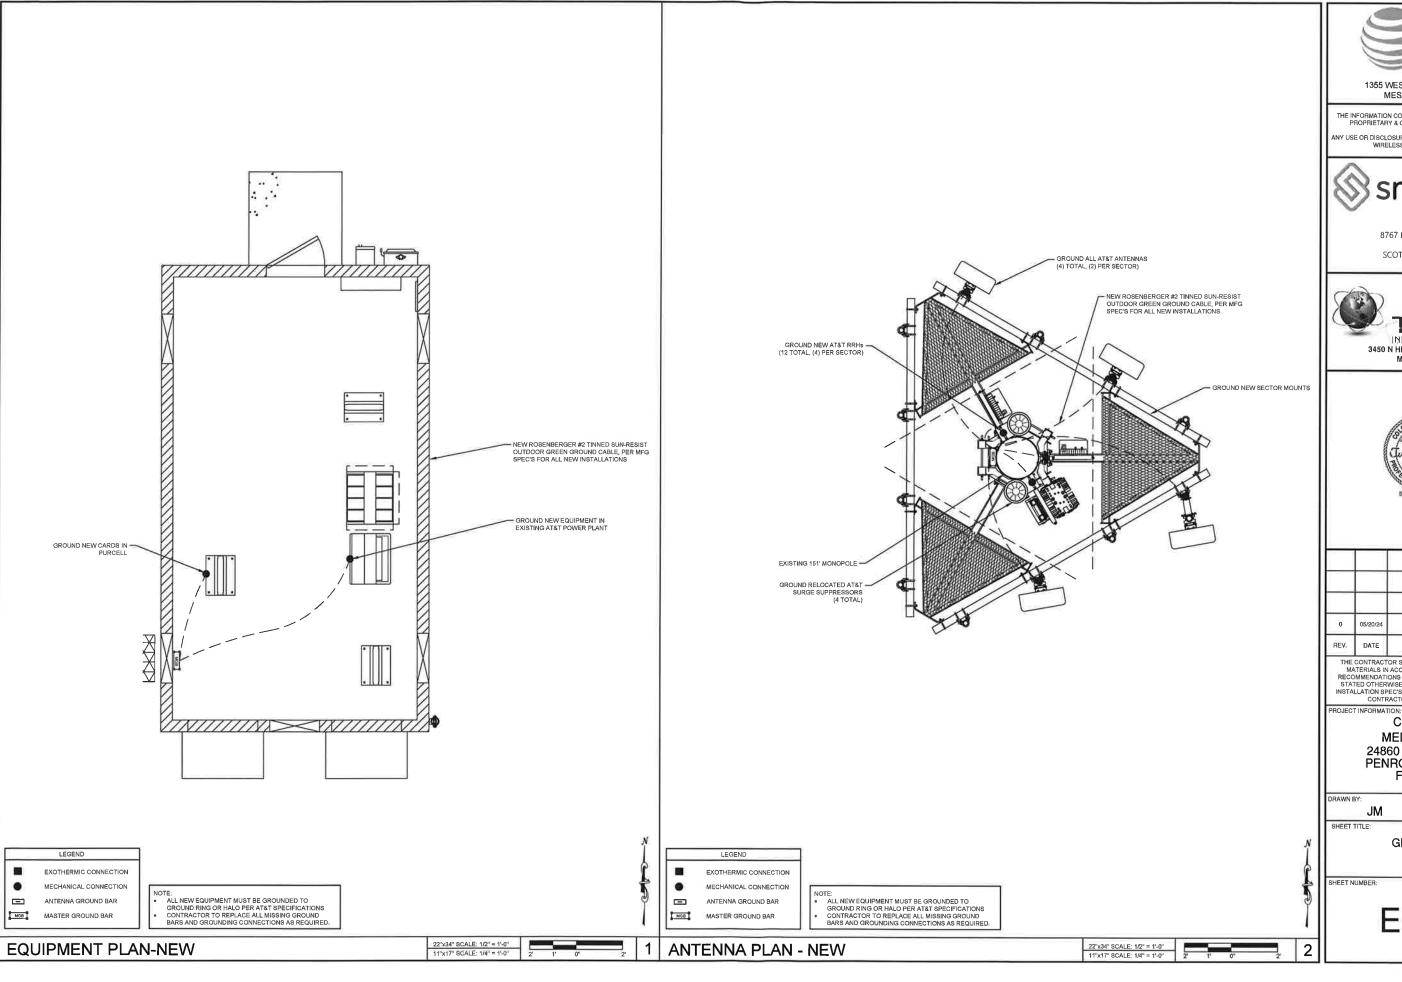
PRELIMINARY REVISION DESCRIPTION

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> CHECKED BY: CM

ELEVATIONS EXISTING & NEW





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3450 N HIGLEY RD - SUITE 102, MESA, AZ 85215



REVISION DESCRIPTION

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COLO6032 **MEDIAN POINT** 24860 HIGHWAY 115 PENROSE, CO 81240 FREMONT


GROUNDING

PLANS

SHEET NUMBER

CM

API	PROVALS
AT&T (RF):	DATE:
AT&T (CONST.):	DATE:
AT&T (SAM):	DATE:
LANDLORD:	DATE:
LANDLORD:	DATE:

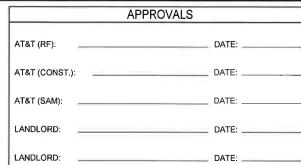



CALL NEVADA ONE CALL (800) 227-2600 **CALL 3 WORKING DAYS** BEFORE YOU DIG!



GENERAL CONTRACTOR NOTES

DO NOT SCALE DRAWINGS

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COLO6032 - PART "B" STANDARD DETAIL, NOTES, SCHEMATICS, AND **DIAGRAMS**

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SUBCONTRACTOR'S WORK SHALL COMPLY WITH ALL APPLICABLE NATIONAL, STATE, AND LOCAL CODES AS ADOPTED BY THE LOCAL AUTHORITY HAVING JURISDICTION (AHJ) FOR THE LOCATION. THE EDITION OF THE AHJ ADOPTED CODES AND STANDARDS IN EFFECT ON THE DATE OF CONTRACT AWARD SHALL GOVERN THE DESIGN.

BUILDING CODE: REFERENCE SITE SPECIFIC DRAWINGS

ELECTRICAL CODE: REFERENCE SITE SPECIFIC DRAWINGS

NATIONAL FIRE PROTECTION ASSOCIATION (NFPA) 70

NATIONAL ELECTRICAL CODE 2011 (WITH CITY AMENDMENTS)

LIGHTNING PROTECTION CODE: NFPA 780 - 2000, LIGHTNING PROTECTION CODE

SUBCONTRACTOR'S WORK SHALL COMPLY WITH THE LATEST EDITION OF THE FOLLOWING STANDARDS: AMERICAN CONCRETE INSTITUTE (ACI) 318, BUILDING CODE REQUIREMENTS FOR STRUCTURAL CONCRETE

AMERICAN INSTITUTE OF STEEL CONSTRUCTION (AISC), MANUAL OF STEEL CONSTRUCTION, ASD, NINTH EDITION TELECOMMUNICATIONS INDUSTRY ASSOCIATION (TIA) 222-G, STRUCTURAL STANDARDS FOR STEEL ANTENNA TOWER AND ANTENNA SUPPORTING STRUCTURES:

TIA 607, COMMERCIAL BUILDING GROUNDING AND BONDING REQUIREMENTS FOR TELECOMMUNICATIONS

INSTITUTE FOR ELECTRICAL AND ELECTRONICS ENGINEERS (IEEE) 81, GUIDE FOR MEASURING EARTH RESISTIVITY, GROUND IMPEDANCE, AND EARTH SURFACE POTENTIALS OF A GROUND SYSTEM IEEE 1100 (1999) RECOMMENDED PRACTICE FOR POWERING AND GROUNDING OF ELECTRONIC EQUIPMENT

IEEE C62.41, RÉCOMMENDED PRACTICES ON SURGE VOLTAGES IN LOW VOLTAGE AC POWER CIRCUITS (FOR LOCATION CATEGORY "C3" AND "HIGH SYSTEM EXPOSURE")

TELCORDIA GR-1275, GENERAL INSTALLATION REQUIREMENTS.

TELCORDIA GR-1503, COAXIAL CABLE CONNECTIONS

ANSI T1.311, FOR TELECOM - DC POWER SYSTEMS - TELECOM, ENVIRONMENTAL PROTECTION

FOR ANY CONFLICTS BETWEEN SECTIONS OF LISTED CODES AND STANDARDS REGARDING MATERIAL, METHODS OF CONSTRUCTION, OR OTHER REQUIREMENTS, THE MOST RESTRICTIVE REQUIREMENT SHALL GOVERN. WHERE THERE IS CONFLICT BETWEEN A GENERAL REQUIREMENT AND A SPECIFIC REQUIREMENT, THE SPECIFIC REQUIREMENT SHALL GOVERN.

SHEET	DESCRIPTION	
T-1B	TITLE SHEET	
T-2B	SPECIFICATIONS	
T-3B	SPECIFICATIONS	
T-4B	LEGEND & ABBREVIATIONS	
D-1B	DETAILS	
D-2B	DETAILS	
G-1B	GROUNDING PLANS, DETAILS & NOTES	



1355 WEST UNIVERSITY DRIVE MESA, AZ 85201-5419

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COLO6032 MEDIAN POINT 24860 HIGHWAY 115 PENROSE, CO 81240 FREMONT

DRAWN BY:	CHECKED BY:
JM	CM
SHEET TITLE:	
	TITLE

SHEET SHEET NUMBER:

T-1B

GENERAL CONSTRUCTION NOTES:

1. FOR THE PURPOSE OF CONSTRUCTION DRAWING, THE FOLLOWING DEFINITIONS SHALL APPLY: CONTRACTOR - GENERAL CONTRACTOR (CONSTRUCTION)

OWNER - AT&T MOBILITY **OEM - ORIGINAL EQUIPMENT MANUFACTURER**

- 2, PRIOR TO THE SUBMISSION OF BIDS, THE BIDDING CONTRACTOR SHALL VISIT THE CELL SITE TO FAMILIARIZE WITH THE EXISTING CONDITIONS AND TO CONFIRM THAT THE WORK CAN BE ACCOMPLISHED AS SHOWN ON THE CONSTRUCTION DRAWINGS, ANY DISCREPANCY FOUND SHALL BE BROUGHT TO THE ATTENTION OF OWNER.
- 3. ALL MATERIALS FURNISHED AND INSTALLED SHALL BE IN STRICT ACCORDANCE WITH ALL APPLICABLE CODES, REGULATIONS, AND ORDINANCES. CONTRACTOR SHALL ISSUE ALL APPROPRIATE NOTICES AND COMPLY WITH ALL LAWS, ORDINANCES, RULES, REGULATIONS, AND LAWFUL ORDERS OF ANY PUBLIC AUTHORITY REGARDING THE PERFORMANCE OF THE WORK, ALL WORK CARRIED OUT SHALL COMPLY WITH ALL APPLICABLE MUNICIPAL AND UTILITY COMPANY SPECIFICATIONS AND LOCAL JURISDICTIONAL CODES, ORDINANCES AND APPLICABLE REGULATIONS,
- 4. DRAWINGS PROVIDED HERE ARE NOT TO BE SCALED AND ARE INTENDED TO SHOW OUTLINE ONLY.
- UNLESS NOTED OTHERWISE, THE WORK SHALL INCLUDE FURNISHING MATERIALS, EQUIPMENT, APPURTENANCES, AND LABOR NECESSARY TO COMPLETE ALL INSTALLATIONS AS INDICATED ON THE DRAWINGS.
- 6. DELETED.
- 7. THE CONTRACTOR SHALL INSTALL ALL EQUIPMENT AND MATERIALS IN ACCORDANCE WITH MANUFACTURER'S RECOMMENDATIONS UNLESS SPECIFICALLY STATED OTHERWISE.
- 8. IF THE SPECIFIED EQUIPMENT CANNOT BE INSTALLED AS SHOWN ON THESE DRAWINGS, THE CONTRACTOR SHALL PROPOSE AN ALTERNATIVE INSTALLATION FOR APPROVAL BY THE CONTRACTOR.
- CONTRACTOR SHALL DETERMINE ACTUAL ROUTING OF CONDUIT, POWER AND T1 CABLES, GROUNDING CABLES AS SHOWN ON THE POWER, GROUNDING AND TELCO PLAN DRAWING, SUBCONTRACTOR SHALL UTILIZE EXISTING TRAYS AND/OR SHALL ADD NEW TRAYS AS NECESSARY. CONTRACTOR SHALL CONFIRM THE ACTUAL ROUTING WITH THE OWNER, ROUTING OF TRENCHING SHALL BE APPROVED BY OWNER.
- 10. THE CONTRACTOR SHALL PROTECT EXISTING IMPROVEMENTS, PAVEMENTS, CURBS, LANDSCAPING AND STRUCTURES. ANY DAMAGED PART SHALL BE REPAIRED AT CONTRACTOR'S EXPENSE TO THE SATISFACTION OF OWNER.
- 11. CONTRACTOR SHALL LEGALLY AND PROPERLY DISPOSE OF ALL SCRAP MATERIALS SUCH AS COAXIAL CABLES AND OTHER ITEMS REMOVED FROM THE EXISTING FACILITY. ANTENNAS REMOVED SHALL BE RETURNED TO THE OWNER'S DESIGNATED LOCATION.
- 12. CONTRACTOR SHALL LEAVE PREMISES IN CLEAN CONDITION.
- 13. ALL CONCRETE REPAIR WORK SHALL BE DONE IN ACCORDANCE WITH AMERICAN CONCRETE INSTITUTE (ACI) 301.
- 14. ANY NEW CONCRETE NEEDED FOR THE CONSTRUCTION SHALL HAVE 4000 PSI STRENGTH AT 28 DAYS UNLESS OTHERWISE SPECIFIED. ALL CONCRETING WORK SHALL BE DONE IN ACCORDANCE WITH ACI 318 CODE REQUIREMENTS.
- 15. ALL STRUCTURAL STEEL WORK SHALL BE DONE IN ACCORDANCE WITH AISC SPECIFICATIONS.
- CONSTRUCTION SHALL COMPLY WITH SPECIFICATION 24782-000-3APS-AOOZ-00002, "GENERAL CONSTRUCTION SERVICES.
- 17. CONTRACTOR SHALL VERIFY ALL EXISTING DIMENSIONS AND CONDITIONS PRIOR TO COMMENCING ANY WORK, ALL DIMENSIONS OF EXISTING CONSTRUCTION SHOWN ON THE DRAWINGS MUST BE VERIFIED. CONTRACTOR SHALL NOTIFY THE OWNER OF ANY DISCREPANCIES PRIOR TO ORDERING MATERIAL OR PROCEEDING WITH CONSTRUCTION.
- 18. THE EXISTING CELL SITE IS IN FULL COMMERCIAL OPERATION. ANY CONSTRUCTION WORK BY CONTRACTOR SHALL NOT DISRUPT THE EXISTING NORMAL OPERATION. ANY WORK ON EXISTING EQUIPMENT MUST BE COORDINATED WITH OWNER. ALSO, WORK MAY NEED TO BE SCHEDULED FOR AN APPROPRIATE MAINTENANCE WINDOW USUALLY IN
- 19. SINCE THE CELL SITE MAY BE ACTIVE, ALL SAFETY PRECAUTIONS MUST BE TAKEN WHEN WORKING AROUND HIGH LEVELS OF ELECTROMAGNETIC RADIATION. EQUIPMENT SHOULD BE SHUTDOWN PRIOR TO PERFORMING ANY WORK THAT COULD EXPOSE THE WORKERS TO DANGER. PERSONAL RF EXPOSURE MONITORS ARE REQUIRED TO BE WORN TO ALERT OF ANY DANGEROUS EXPOSURE LEVELS.

GROUNDING NOTES

- THE CONTRACTOR SHALL REVIEW AND INSPECT THE EXISTING FACILITY GROUNDING SYSTEM AND LIGHTNING PROTECTION SYSTEM (AS DESIGNED AND INSTALLED) FOR STRICT COMPLIANCE WITH THE NEC (AS ADOPTED BY THE AHJ), THE SITE-SPECIFIC (UL, LPI, OR NFPA) LIGHTING PROTECTION CODE, AND GENERAL COMPLIANCE WITH TELCORDIA AND TIA GROUNDING STANDARDS, THE CONTRACTOR SHALL REPORT ANY VIOLATIONS OR ADVERSE FINDINGS TO THE OWNER FOR RESOLUTION.
- ALL GROUND ELECTRODE SYSTEMS (INCLUDING TELECOMMUNICATION, RADIO, LIGHTNING PROTECTION, AND AC POWER GES'S) SHALL BE BONDED TOGETHER, AT OR BELOW GRADE, BY TWO OR MORE COPPER BONDING CONDUCTORS IN ACCORDANCE WITH THE NEC.
- THE CONTRACTOR SHALL PERFORM IEEE FALL-OF-POTENTIAL RESISTANCE TO EARTH TESTING (PER IEEE 1100 AND 81) FOR NEW GROUND ELECTRODE SYSTEMS. THE CONTRACTOR SHALL FURNISH AND INSTALL SUPPLEMENTAL GROUND ELECTRODES AS NEEDED TO ACHIEVE A TEST RESULT OF 5 OHMS OR LESS, TESTS SHALL BE PERFORMED IN ACCORDANCE WITH 24782-000-3PS-EG00-0001, DESIGN & TESTING OF FACILITY GROUNDING FOR CELL SITES.
- METAL RACEWAY SHALL NOT BE USED AS THE NEC REQUIRED EQUIPMENT GROUND CONDUCTOR. STRANDED COPPER CONDUCTORS WITH GREEN INSULATION, SIZED IN ACCORDANCE WITH THE NEC, SHALL BE FURNISHED AND INSTALLED WITH THE POWER CIRCUITS TO BTS EQUIPMENT
- EACH BTS CABINET FRAME SHALL BE DIRECTLY CONNECTED TO THE MASTER GROUND BAR WITH GREEN INSULATED SUPPLEMENTAL EQUIPMENT GROUND WIRES, 6 AWG STRANDED COPPER OR LARGER FOR INDOOR BTS; 2 AWS STRANDED COPPER FOR OUTDOOR BTS.
- 6. EXOTHERMIC WELDS SHALL BE USED FOR ALL GROUNDING CONNECTIONS BELOW GRADE:
- APPROVED ANTIOXIDANT COATINGS (I.E., CONDUCTIVE GEL OR PASTE) SHALL BE USED ON ALL COMPRESSION AND **BOLTED GROUND CONNECTIONS**
- 8. ICE BRIDGE BONDING CONDUCTORS SHALL BE EXOTHERMICALLY BONDED OR BOLTED WITH STAINLESS STEEL HARDWARE TO THE BRIDGE AND THE TOWER GROUND BAR.
- ALUMINUM CONDUCTOR OR COPPER CLAD STEEL CONDUCTOR SHALL NOT BE USED FOR GROUNDING CONNECTIONS.
- 10. MISCELLANEOUS ELECTRICAL AND NON-ELECTRICAL METAL BOXES, FRAMES AND SUPPORTS SHALL BE BONDED TO THE GROUND RING, IN ACCORDANCE WITH THE NEC.
- 11. METAL CONDUIT AND TRAY SHALL BE GROUNDED AND MADE ELECTRICALLY CONTINUOUS WITH LISTED BONDING FITTINGS OR BY BONDING ACROSS THE DISCONTINUITY WITH 6 AWG COPPER WIRE UL APPROVED GROUNDING TYPE CONDUIT
- 12. GROUND CONDUCTORS USED IN THE FACILITY GROUND AND LIGHTNING PROTECTION SYSTEMS SHALL NOT BE ROUTED THROUGH METALLIC OBJECTS THAT FORM A RING AROUND THE CONDUCTOR, SUCH AS METALLIC CONDUITS, METAL SUPPORT CLIPS OR SLEEVES THROUGH WALLS OR FLOORS. WHEN IT IS REQUIRED TO BE HOUSED IN CONDUIT TO MEET CODE REQUIREMENTS OR LOCAL CONDITIONS, NON-METALLIC MATERIAL SUCH AS PVC PLASTIC CONDUIT SHALL BE USED. WHERE USE OF METAL CONDUIT IS UNAVOIDABLE (E.G., NON-METALIC CONDUIT PROHIBITED BY LOCAL CODE) THE GROUND CONDUCTOR SHALL BE BONDED TO EACH END OF THE METAL CONDUIT.
- 13. ALL TOWER GROUNDING SYSTEMS SHALL COMPLY WITH THE REQUIREMENTS OF ANSI/TIA 222. FOR TOWERS BEING BUILT TO REV G OF THE STANDARD, THE WIRE SIZE OF THE BURIED GROUND RING AND CONNECTIONS BETWEEN THE TOWER AND THE BURIED GROUND RING SHALL BE CHANGED FROM 2 AWG TO 2/0 AWG. IN ADDITION, THE MINIMUM LENGTH OF THE GROUND RODS SHALL BE INCREASED FROM 8 FEET TO 10 FEET.



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THE CONTRACTOR SHALL INSTALL ALL EQUIPMENT AND

STATED OTHERWISE, THE MANUFACTURES EQUIPMENT INSTALLATION SPEC'S SHALL ALWAYS BE VERIFIED BY THE CONTRACTOR BEFORE INSTALLATION

PROJECT INFORMATION

COLO6032 MEDIAN POINT 24860 HIGHWAY 115 PENROSE, CO 81240 FREMONT

DRAWN BY CHECKED BY CM SHEET TITLE

SPECIFICATIONS

SHEET NUMBER

CONCRETE AND REINFORCING STEEL NOTES:

- ALL CONCRETE WORK SHALL BE IN ACCORDANCE WITH THE ACI 301, ACI 318, ACI 336, ASTM A184, ASTM A185 AND THE DESIGN AND CONSTRUCTION SPECIFICATION FOR CAST-IN-PLACE CONCRETE.
- 2. ALL CONCRETE SHALL HAVE A MINIMUM COMPRESSIVE STRENGTH OF 4000 PSI AT 28 DAYS, UNLESS NOTED OTHERWISE.
- REINFORCING STEEL SHALL CONFORM TO ASTM A 615, GRADE 60, DEFORMED UNLESS NOTED OTHERWISE. WELDED WIRE FABRIC SHALL CONFORM TO ASTM A 185 WELDED STEEL WIRE FABRIC UNLESS NOTED OTHERWISE. SPLICES SHALL BE CLASS "B" AND ALL HOOKS SHALL BE STANDARD, U.N.O.
- 4. THE FOLLOWING MINIMUM CONCRETE COVER SHALL BE PROVIDED FOR REINFORCING STEEL UNLESS SHOWN OTHERWISE ON DRAWINGS.

CONCRETE CAST AGAINST EARTH

CONCRETE EXPOSED TO EARTH OR WEATHER:

#6 AND LARGER #5 AND SMALLER & WWF

1-1/2 IN

CONCRETE NOT EXPOSED TO EARTH OR WEATHER, NOR CAST AGAINST THE GROUND:

SLAB AND WALL

3/4 IN 1-1/2 IN

REAMS AND COLUMNS

- 5. A 3/4" CHAMFER SHALL BE PROVIDED AT ALL EXPOSED EDGES OF CONCRETE, U.N.O., IN ACCORDANCE WITH ACI 301 SECTION 4.2.4.
- INSTALLATION OF CONCRETE EXPANSION/WEDGE ANCHOR, SHALL BE PER MANUFACTURER'S WRITTEN RECOMMENDED PROCEDURE. THE ANCHOR BOLT, DOWEL OR ROD SHALL CONFORM TO MANUFACTURER'S RECOMMENDATION FOR EMBEDMENT DEPTH OR AS SHOWN ON THE DRAWINGS. NO REBAR SHALL BE CUT WITHOUT PRIOR ENGINEERING APPROVAL WHEN DRILLING HOLES IN CONCRETE, EXPANSION BOLTS SHALL BE PROVIDED BY RAMSET/REDHEAD OR APPROVED EQUAL.
- CONCRETE CYLINDER TEST IS NOT REQUIRED FOR SLAB ON GRADE WHEN CONCRETE IS LESS THAN 50 CUBIC YARDS (UBC 1905.6.1.3) IN THAT EVENT THE FOLLOWING RECORDS SHALL BE PROVIDED BY THE CONCRETE SUPPLIER.

(A) RESULTS OF CONCRETE CYLINDER TESTS PERFORMED AT THE SUPPLIER'S PLANT,

(B) CERTIFICATION OF MINIMUM COMPRESSIVE STRENGTH FOR THE CONCRETE GRADE SUPPLIED. FOR GREATER THAN 50 CUBIC YARDS THE GC SHALL PERFORM THE CONCRETE CYLINDER TEST

SPECIFICATIONS

SITE WORK GENERAL NOTES:

- 1. THE CONTRACTOR SHALL CONTACT UTILITY LOCATING SERVICES PRIOR TO THE START OF CONSTRUCTION.
- 2. ALL EXISTING ACTIVE SEWER, WATER, GAS, ELECTRIC, AND OTHER UTILITIES WHERE ENCOUNTERED IN THE WORK, SHALL BE PROTECTED AT ALL TIMES, AND WHERE REQUIRED FOR THE PROPER EXECUTION OF THE WORK, SHALL BE RELOCATED AS DIRECTED BY CONTRACTOR, EXTREME CAUTION SHOULD BE USED BY THE CONTRACTOR WHEN EXCAVATING OR DRILLING PIERS AROUND OR NEAR UTILITIES. CONTRACTOR SHALL PROVIDE SAFETY TRAINING FOR THE WORKING CREW. THIS WILL INCLUDE BUT NOT BE LIMITED TO A) FALL PROTECTION B) CONFINED SPACE C) ELECTRICAL SAFETY D) TRENCHING & EXCAVATION.
- 3. ALL SITE WORK SHALL BE AS INDICATED ON THE DRAWINGS AND PROJECT SPECIFICATIONS.
- 4. IF NECESSARY, RUBBISH, STUMPS, DEBRIS, STICKS, STONES AND OTHER REFUSE SHALL BE REMOVED FROM THE SITE AND DISPOSED OF LEGALLY.
- 5. ALL EXISTING INACTIVE SEWER, WATER, GAS, ELECTRIC AND OTHER UTILITIES, WHICH INTERFERE WITH THE EXECUTION OF THE WORK, SHALL BE REMOVED AND/OR CAPPED, PLUGGED OR OTHERWISE DISCONTINUED AT POINTS WHICH WILL NOT INTERFERE WITH THE EXECUTION OF THE WORK, SUBJECT TO THE APPROVAL OF CONTRACTOR, OWNER AND/OR LOCAL UTILITIES.
- CONTRACTOR SHALL MINIMIZE DISTURBANCE TO EXISTING SITE DURING CONSTRUCTION.
- 7. THE CONTRACTOR SHALL PROVIDE SITE SIGNAGE IN ACCORDANCE WITH THE AT&T MOBILITY SPECIFICATION FOR SITE SIGNAGE.
- 8. THE SITE SHALL BE GRADED TO CAUSE SURFACE WATER TO FLOW AWAY FROM THE BTS EQUIPMENT AND TOWER AREAS.
- 9. NO FILL OR EMBANKMENT MATERIAL SHALL BE PLACED ON FROZEN GROUND. FROZEN MATERIALS, SNOW OR ICE SHALL NOT BE PLACED IN ANY FILL OR EMBANKMENT.
- 10. THE SUB GRADE SHALL BE COMPACTED AND BROUGHT TO A SMOOTH UNIFORM GRADE PRIOR TO FINISHED SURFACE APPLICATION.
- 11, THE AREAS OF THE OWNERS PROPERTY DISTURBED BY THE WORK AND NOT COVERED BY THE TOWER, EQUIPMENT OR DRIVEWAY, SHALL BE GRADED TO A UNIFORM SLOPE, AND STABILIZED TO PREVENT EROSION.
- 12. CONTRACTOR SHALL MINIMIZE DISTURBANCE TO EXISTING SITE DURING CONSTRUCTION. EROSION CONTROL MEASURES, IF REQUIRED DURING CONSTRUCTION, SHALL BE IN CONFORMANCE WITH THE LOCAL JURISDICTION'S GUIDELINES FOR EROSION AND SEDIMENT CONTROL.

STRUCTURAL STEEL NOTES

- 1. ALL STEEL WORK SHALL BE PAINTED IN ACCORDANCE WITH THE PROJECT SPECIFICATIONS AND IN ACCORDANCE WITH ASTM A36
- ALL WELDING SHALL BE PERFORMED USING E70XX ELECTRODES AND WELDING SHALL CONFORM TO AISC. WHERE FILLET WELD SIZES ARE NOT SHOWN, PROVIDE THE MINIMUM SIZE PER TABLE J2.4 IN THE AISC "MANUAL OF STEEL CONSTRUCTION". PAINTED SURFACES SHALL BE TOUCHED UP.
- 3. BOLTED CONNECTIONS SHALL BE ASTM A325 BEARING TYPE (3/4"Ø) CONNECTIONS AND SHALL HAVE MINIMUM OF TWO BOLTS UNLESS NOTED OTHERWISE.
- 4. NON-STRUCTURAL CONNECTIONS FOR STEEL GRATING MAY USE 5/8" DIA. ASTM A 307 BOLTS UNLESS NOTED OTHERWISE.
- 5. INSTALLATION OF CONCRETE EXPANSION/WEDGE ANCHOR, SHALL BE PER MANUFACTURER'S WRITTEN RECOMMENDED PROCEDURE. THE ANCHOR BOLT, DOWEL OR ROD SHALL CONFORM TO MANUFACTURER'S RECOMMENDATION FOR EMBEDMENT DEPTH OR AS SHOWN ON THE DRAWINGS. NO REBAR SHALL BE CUT WITHOUT PRIOR CONTRACTOR APPROVAL WHEN DRILLING HOLES IN CONCRETE. SPECIAL INSPECTIONS, REQUIRED BY GOVERNING CODES, SHALL BE PERFORMED IN ORDER TO MAINTAIN MANUFACTURER'S MAXIMUM ALLOWABLE LOADS.
- 6. ALL EXPANSION/WEDGE ANCHORS SHALL BE STAINLESS STEEL OR HOT DIPPED GALVANIZED. THE ANCHOR BOLT DOWEL AND ROD SHALL BE STAINLESS STEEL WITH STAINLESS STEEL WASHERS.

SOIL COMPACTION NOTES FOR SLAB ON GRADE:

- 1. EXCAVATE AS REQUIRED TO REMOVE VEGETATION & TOPSOIL EXPOSE UNDISTURBED NATURAL SUBGRADE AND PLACE CRUSHED STONE AS REQUIRED.
- 2. COMPACTION CERTIFICATION: AN INSPECTION AND WRITTEN CERTIFICATION BY A QUALIFIED GEOTECHNICAL TECHNICIAN OR ENGINEER IS ACCEPTABLE.
- 3. AS AN ALTERNATIVE TO INSPECTION AND WRITTEN CERTIFICATION, THE "UNDISTURBED SOIL" BASE SHALL BE COMPACTED WITH "COMPACTION EQUIPMENT", LISTED BELOW, TO AT LEAST 90% MODIFIED PROCTOR MAXIMUM DENSITY PER ASTM D 1557 METHOD C.
- 4. COMPACTED SUBBASE SHALL BE UNIFORM & LEVELED. PROVIDE 6" MINIMUM CRUSHED STONE OR GRAVEL COMPACTED IN 3" LIFTS ABOVE COMPACTED SOIL. GRAVEL SHALL BE NATURAL OR CRUSHED WITH 100% PASSING 1" SIEVE.

COMPACTION EQUIPMENT:

HAND OPERATED DOUBLE DRUM, VIBRATORY ROLLER, VIBRATORY PLATE COMPACTOR OR JUMPING JACK COMPACTOR.

ELECTRICAL INSTALLATION NOTES:

- 1. WIRING, RACEWAY, AND SUPPORT METHODS AND MATERIALS SHALL COMPLY WITH THE REQUIREMENTS OF THE NEC AND TELCORDIA.
- 2. CONTRACTOR SHALL MODIFY EXISTING CABLE TRAY SYSTEM AS REQUIRED TO SUPPORT RF AND TRANSPORT CABLING TO THE NEW BTS EQUIPMENT. CONTRACTOR SHALL SUBMIT MODIFICATIONS TO OWNER FOR APPROVAL.
- 3. ALL CIRCUITS SHALL BE SEGREGATED AND MAINTAIN MINIMUM CABLE SEPARATION AS REQUIRED BY THE NEC AND TELCORDIA.
- 4. CABLES SHALL NOT BE ROUTED THROUGH LADDER-STYLE CABLE TRAY RUNGS,
- EACH END OF EVERY POWER, GROUNDING, AND T1 CONDUCTOR AND CABLE SHALL BE LABELED WITH COLOR-CODED INSULATION OR ELECTRICAL TAPE (3M BRAND, 1/2 INCH PLASTIC ELECTRICAL TAPE WITH UV PROTECTION, OR EQUAL). THE IDENTIFICATION METHOD SHALL CONFORM WITH NEC & OSHA, AND MATCH EXISTING INSTALLATION REQUIREMENTS.
- 6. POWER PHASE CONDUCTORS (I.E., HOTS)SHALL BE LABELED WITH COLOR-CODED INSULATION OR ELECTRICAL TAPE (3M BRAND, 1/2 INCH PLASTIC ELECTRICAL TAPE WITH UV PROTECTION, OR EQUAL). PHASE CONDUCTOR COLOR CODE3S SHALL CONFORM WITH THE NEC & OSHA AND MATCH EXISTING INSTALLATION REQUIREMENTS..
- ALL ELECTRICAL COMPONENTS SHALL BE CLEARLY LABELED WITH ENGRAVED LAMACOID PLASTIC LABELS, ALL EQUIPMENT SHALL BE LABELED WITH THEIR VOLTAGE
 RATING, PHASE CONFIGURATION, WIRE CONFIGURATION, POWER OR AMPACITY RATING, AND BRANCH CIRCUIT ID NUMBERS (I.E., PANELBOARD AND CIRCUIT ID'S)...
- 8. PANELBOARDS (ID NUMBERS) AND INTERNAL CIRCUIT BREAKERS (CIRCUIT ID NUMBERS) SHALL BE CLEARLY LABELED WITH ENGRAVED LAMACOID PLASTIC LABELS.
- 9. ALL TIE WRAPS WHERE PERMITTED SHALL BE CUT FLUSH WITH APPROVED CUTTING TOOL TO REMOVE SHARP EDGES, USE LOW PROFILE TIE WRAPS,
- 10. POWER, CONTROL, AND EQUIPMENT GROUND WIRING IN TUBING OR CONDUIT SHALL BE SINGLE CONDUCTOR (12 AWG OR LARGER), 600 V, OIL RESISTANT THHN OR THWN-2, CLASS B STRANDED COPPER CABLE RATED FOR 90 °C (WET AND DRY) OPERATION; LISTED OR LABELED FOR THE LOCATION AND RACEWAY SYSTEM USED, UNLESS OTHERWISE SPECIFIED.
- 11. SUPPLEMENTAL EQUIPMENT GROUND WIRING LOCATED INDOORS SHALL BE SINGLE CONDUCTOR (6 AWG OR LARGER), 600 V, OIL RESISTANT THHN OR THWN-2 GREEN INSULATION, CLASS B STRANDED COPPER CABLE RATED FOR 90 °C (WET AND DRY) OPERATION; LISTED OR LABELED FOR THE LOCATION AND RACEWAY SYSTEM USED, UNLESS OTHERWISE SPECIFIED.
- 12. SUPPLEMENTAL EQUIPMENT GROUND WIRING LOCATED OUTDOORS, OR BELOW GRADE, SHALL BE SINGLE CONDUCTOR 2 AWG SOLID TINNED COPPER CABLE, UNLESS OTHERWISE SPECIFIED.
- 13. POWER WIRING, NOT IN TUBING OR CONDUIT, SHALL BE MULTI-CONDUCTOR, TYPE TC CABLE (12 AWG OR LARGER), 600 V, OIL RESISTANT THHN OR THWN-2, CLASS B STRANDED COPPER CABLE RATED FOR 90 °C (WET AND DRY) OPERATION; WITH OUTER JACKET; LISTED OR LABELED FOR THE LOCATION USED, UNLESS OTHERWISE SPECIFIED.
- 14. ALL POWER AND GROUNDING CONNECTIONS SHALL BE CRIMP-STYLE, COMPRESSION WIRE LUGS AND WIRENUTS BY THOMAS AND BETTS (OR EQUAL). LUGS AND WIRENUTS SHALL BE RATED FOR OPERATION AT NO LESS THAN 75°C (90°C IF AVAILABLE).
- 15. RACEWAY AND CABLE TRAY SHALL BE LISTED OR LABELED FOR ELECTRICAL USE IN ACCORDANCE WITH NEMA, UL, ANSI/IEEE, AND NEC.
- 16, NEW RACEWAY OR CABLE TRAY WILL MATCH THE EXISTING INSTALLATION WHERE POSSIBLE,
- 17. ELECTRICAL METALLIC TUBING (EMT) OR RIGID NONMETALLIC CONDUIT (I.E., RIGID PVC SCHEDULE 40, OR RIGID PVC SCHEDULE 80 FOR LOCATIONS SUBJECT TO PHYSICAL DAMAGE) SHALL BE USED FOR EXPOSED INDOOR LOCATIONS.
- ELECTRICAL METALLIC TUBING (EMT), ELECTRICAL NONMETALLIC TUBING (ENT), OR RIGID NONMETALLIC CONDUIT (RIGID PVC, SCHEDULE 40) SHALL BE USED FOR CONCEALED INDOOR LOCATIONS.
- 19. GALVANIZED STEEL INTERMEDIATE METALLIC CONDUIT (IMC) SHALL BE USED FOR OUTDOOR LOCATIONS ABOVE GRADE.
- 20. RIGID NONMETALLIC CONDUIT (I.E., RIGID PVC SCHEDULE 40 OR RIGID PVC SCHEDULE 80) SHALL BE USED UNDERGROUND; DIRECT BURIED, IN AREAS OF OCCASIONAL LIGHT VEHICLE TRAFFIC OR ENCASED IN REINFORCED CONCRETE IN AREAS OF HEAVY VEHICLE TRAFFIC.
- 21. LIQUID-TIGHT FLEXIBLE METALLIC CONDUIT (LIQUID-TITE FLEX) SHALL BE USED INDOORS AND OUTDOORS, WHERE VIBRATION OCCURS OR FLEXIBILITY IS NEEDED.
- 22. CONDUIT AND TUBING FITTINGS SHALL BE THREADED OR COMPRESSION-TYPE AND APPROVED FOR THE LOCATION USED. SETSCREW FITTINGS ARE NOT ACCEPTABLE.
- 23. CABINETS, BOXES, AND WIREWAYS SHALL BE LISTED OR LABELED FOR ELECTRICAL USE IN ACCORDANCE WITH NEMA, UL, ANSI/IEEE, AND NEC.
- 24. CABINETS, BOXES, AND WIREWAYS TO MATCH THE EXISTING INSTALLATION WHERE POSSIBLE.
- 25. WIREWAYS SHALL BE EPOXY-COATED (GRAY) AND INCLUDE A HINGED COVER, DESIGNED TO SWING OPEN DOWNWARD; SHALL BE PANDUIT TYPE E (OR EQUAL); AND RATED NEMA 1 (OR BETTER) INDOORS, OR NEMA 3R (OR BETTER) OUTDOORS.
- 26. EQUIPMENT CABINETS, TERMINAL BOXES, JUNCTION BOXES, AND PULL BOXES SHALL BE GALVANIZED OR EPOXY-COATED SHEET STEEL, SHALL MEET OR EXCEED UL 50, AND RATED NEMA 1 (OR BETTER) INDOORS, OR NEMA 3R (OR BETTER) OUTDOORS.
- 27. METAL RECEPTACLE, SWITCH, AND DEVICE BOXES SHALL BE GALVANIZED, EPOXY-COATED, OR NON-CORRODING; SHALL MEET OR EXCEED UL 514A AND NEMA OS 1; AND RATED NEMA 1 (OR BETTER) INDOORS, OR WEATHER PROTECTED (WP OR BETTER) OUTDOORS.
- 28. NONMETALLIC RECEPTACLE, SWITCH, AND DEVICE BOXES SHALL MEET OR EXCEED NEMA OS 2; AND RATED NEMA 1 (OR BETTER) INDOORS, OR WEATHER PROTECTED (WP OR BETTER) OUTDOORS.
- 29. THE CONTRACTOR SHALL NOTIFY AND OBTAIN NECESSARY AUTHORIZATION FROM THE OWNER BEFORE COMMENCING WORK ON THE AC POWER DISTRIBUTION PANELS.
- 30, THE CONTRACTOR SHALL PROVIDE NECESSARY TAGGING ON THE BREAKERS, CABLES AND DISTRIBUTION PANELS IN ACCORDANCE WITH THE APPLICABLE CODS AND STANDARDS TO SAFEGUARD AGAINST LIFE AND PROPERTY.



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REV. DATE REVISION DESCRIPTION

THE CONTRACTOR SHALL INSTALL ALL EQUIPMENT AND

THE CONTRACTOR SHALL INSTALL ALL EQUIPMENT AND MATERIALS IN ACCORDANCE WITH MANUFACTURES RECOMMENDATIONS AND SPEC'S, UNLESS SPECIFICALLY STATED OTHERWISE, THE MANUFACTURES EQUIPMENT INSTALLATION SPEC'S SHALL ALWAYS BE VERIFIED BY THE CONTRACTOR BEFORE INSTALLATION

PROJECT INFORMAT


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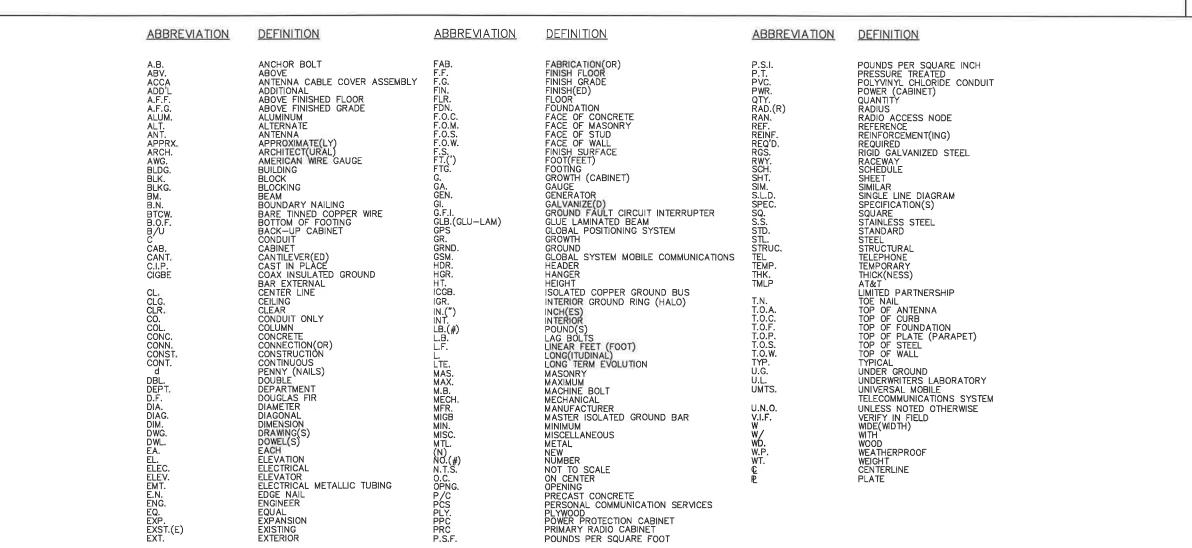
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REV.	DATE	REVISION DESCRIPTION
THE CONTRACTOR SHALL INSTALL ALL EQUIPMENT AND MATERIALS IN ACCORDANCE WITH MANUFACTURES		

THE CONTRACTOR SHALL INSTALL ALL EQUIPMENT AND MATERIALS IN ACCORDANCE WITH MANUFACTURES RECOMMENDATIONS AND SPEC'S, UNLESS SPECIFICALLY STATED OTHERWISE, THE MANUFACTURES EQUIPMENT INSTALLATION SPEC'S SHALL ALWAYS BE VERIFIED BY THE CONTRACTOR BEFORE INSTALLATION.

PROJECT INFORMATION

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DRAWN BY: CH

LEGEND & ABBREVIATIONS

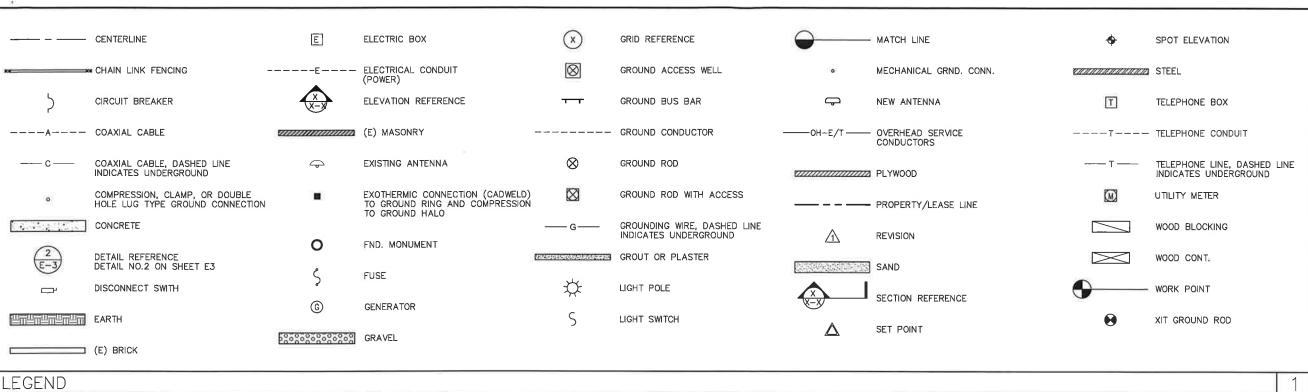
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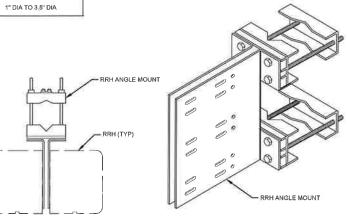
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CM



BACK TO BACK ANGLE MOUNT

ERICSSON SXK 1255394/2		
TOTAL WEIGHT (UNFINISHED)	22LBS 10KG	
ROUND LEGS	1/2" DIA TO 5" DIA	
60 DEGREÉ ANGLE LEGS	1" DIA TO 5" DIA	
90 DEGREE ANGLE LEGS	1" DIA TO 3,5" DIA	

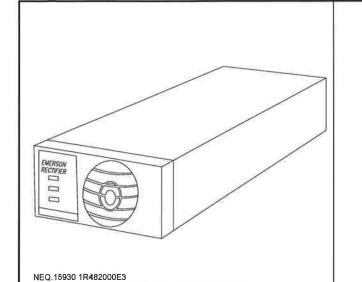

RECTIFIER DETAIL


RRH DETAILS

RECTIFIER, NETSURE™ 512 & 721, HIGH EFFICIENCY, -48 VDC, 40 A/2000 W, 120/208/240 VAC, SINGLE-PHASE INPUT, 4.4 LBS.


1 NOT USED

NOT TO SCALE 2 RRH MOUNTING DETAIL

NOT TO SCALE 3

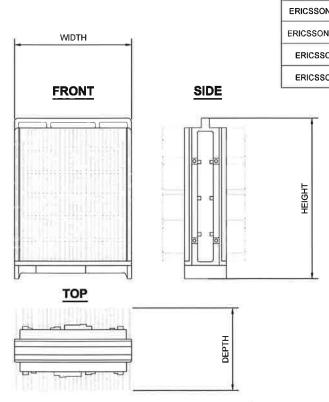

RRH MODEL DIMENSIONS (HXWXD) ERICSSON 4490 B5/B12 17.5"X15.2"X6.8" ERICSSON 4890 B25/B66 17.5"X15.1"X6.9" 69.5 16.5"X13.5"X5.9" ERICSSON 4415 B30 46.3 ERICSSON 4478 B14 15.0"X13.2"X7.3" 59.4

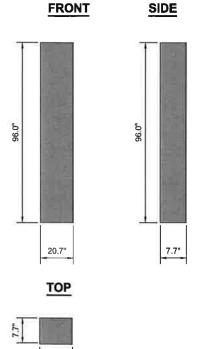

CCI

TPA65R-BU8D

WEIGHT W/O PREMOUNTED BRACKETS: 87,1 LBS

CM

NOT TO SCALE 4 ANTENNA DETAILS

NOT TO SCALE 5

SHEET TITLE:

SHEET NUMBER:

REV.

DATE

D-1B

DETAILS

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3450 N HIGLEY RD - SUITE 102, MESA, AZ 85215


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INFRASTRUCTURE SERVICES

REVISION DESCRIPTION

THE CONTRACTOR SHALL INSTALL ALL EQUIPMENT AND MATERIALS IN ACCORDANCE WITH MANUFACTURES RECOMMENDATIONS AND SPEC'S, UNLESS SPECIFICALLY STATED OTHERWISE, THE MANUFACTURES EQUIPMENT INSTALLATION SPEC'S SHALL ALWAYS BE VER

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STAND-OFF MOUNT DETAIL

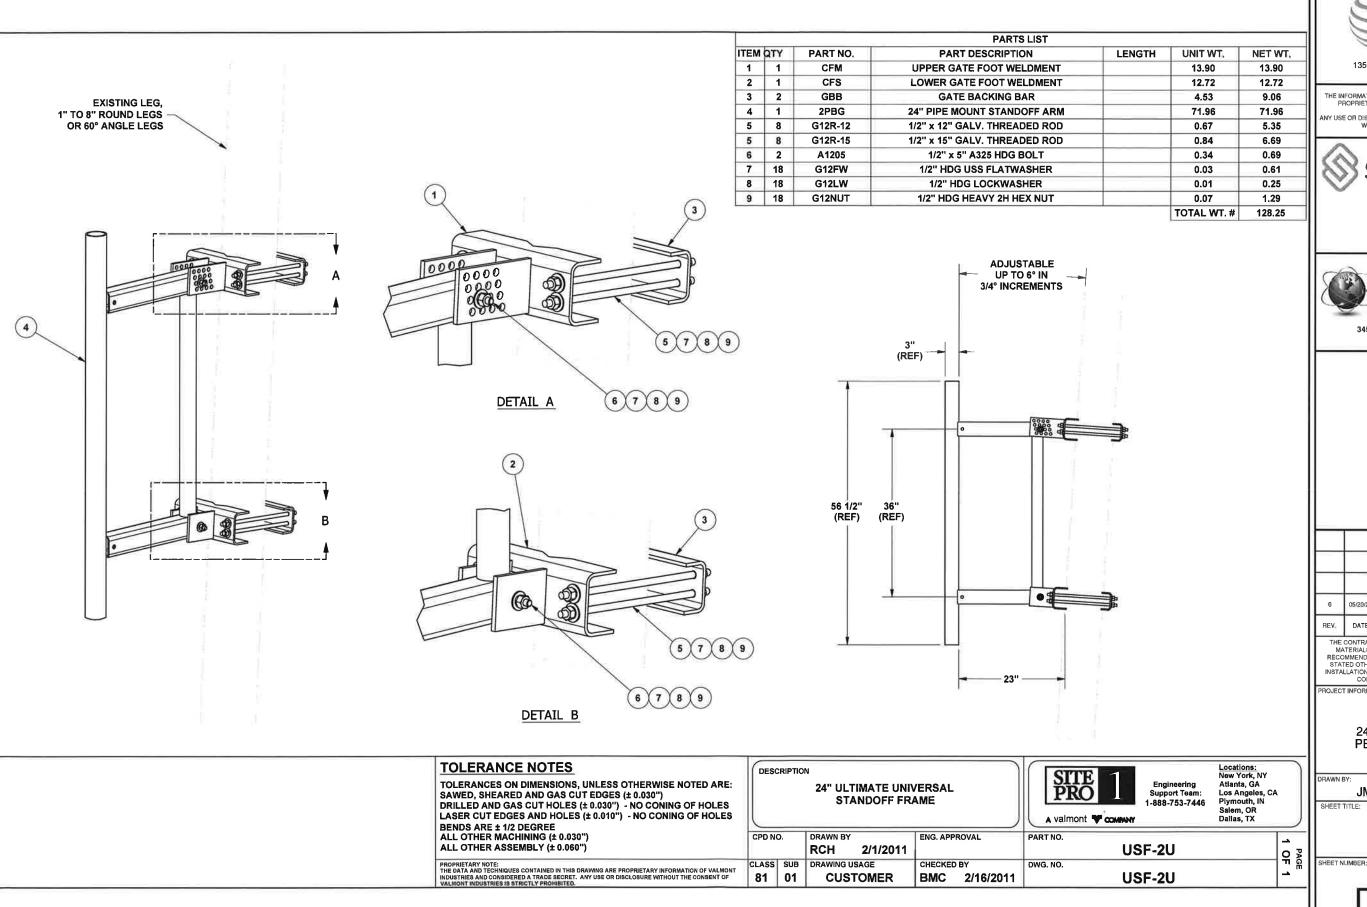

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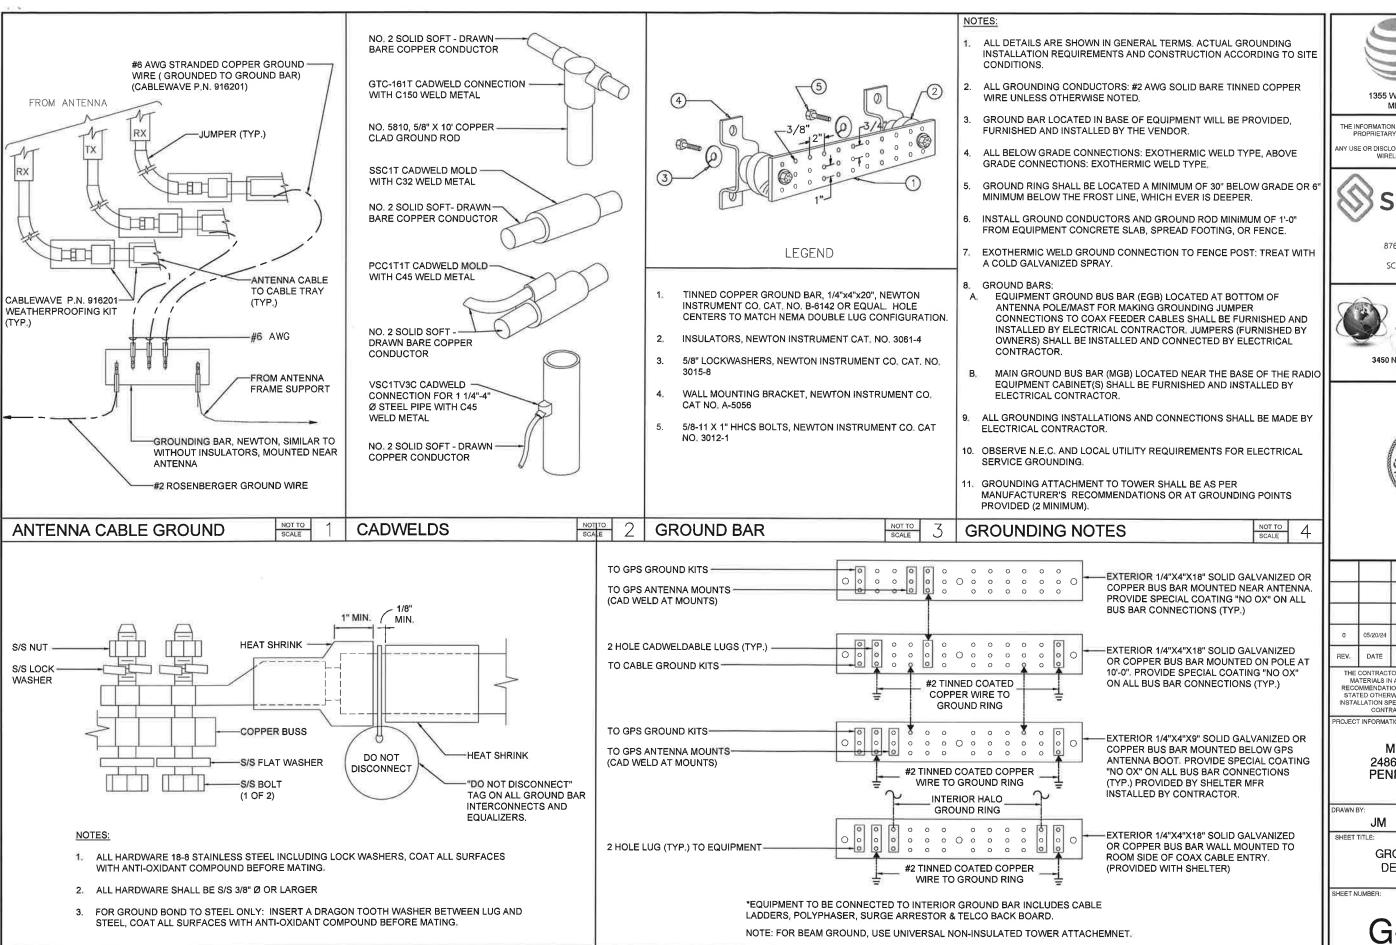
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DETAILS

D-2B

NOT TO SCALE



NOT TO

GROUND BAR

TWO LUG GROUND

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INFRASTRUCTURE SERVICES 3450 N HIGLEY RD - SUITE 102, MESA, AZ 85215



PRELIMINARY REVISION DESCRIPTION

MATERIALS IN ACCORDANCE WITH MANUFACTURES RECOMMENDATIONS AND SPEC'S, UNLESS SPECIFICALLY STATED OTHERWISE, THE MANUFACTURES EQUIPMENT INSTALLATION SPEC'S SHALL ALWAYS BE VERIFIED BY THE CONTRACTOR BEFORE INSTALLATION

NOT TO

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COLO6032 **MEDIAN POINT** 24860 HIGHWAY 115 PENROSE, CO 81240 FREMONT

> HECKED BY CM

GROUNDING PLANS DETAILS & NOTES

G-1B