



ATC SITE NAME: CANON CITY ATC SITE NUMBER: 370533 T-MOBILE SITE NAME: DN04300B T-MOBILE SITE NUMBER: DN04300B

SITE ADDRESS: 12868 CR 3 CANON CITY, CO 81212-0000

SITE CLASS: SELF SUPPORT



LOCATION MAP

BACKHAUL UPGRADE_MW UPGRADE SECOND_SITE MOD DN04300B-0002175609

COMPLIANCE CODE	PROJECT SUMMARY	PROJECT DESCRIPTION		SHEET INDEX	(
ALL WORK SHALL BE PERFORMED AND MATERIALS INSTALLED IN ACCORDANCE WITH THE CURRENT EDITIONS OF THE FOLLOWING CODES AS ADOPTED BY THE LOCAL	SITE ADDRESS: 12868 CR 3	THE PROPOSED PROJECT INCLUDES MODIFYING GROUND BASED AND TOWER MOUNTED EQUIPMENT AS INDICATED PER BELOW:	SHEET NO:	DESCRIPTION:	REV:	DATE:	BY:
GOVERNMENT AUTHORITIES. NOTHING IN THESE PLANS IS TO BE CONSTRUED TO PERMIT WORK NOT CONFORMING TO THESE CODES. 1. 2021 INTERNATIONAL BUILDING CODE (IBC) 2. 2023 NATIONAL ELECTRICAL CODE (NEC) 3. LOCAL BUILDING CODE 4. CITY/COUNTY ORDINANCES	CANON CITY, CO 81212-0000	TOWER WORK: REMOVE (1) COAX CABLE AND (1) RFU-C ODU INSTALL FIBEAIR IP-20D ODU, (1) 3/8" FIBER CABLE AND (1) 5/8" POWER CABLE EXISTING (6) ANTENNAS AND (2) PENDANT CONNECT(s) TO REMAIN EXISTING (6) RRH(s) W/ SWIVEL MOUNT(s) TO BE RELOCATED TO	G-001	TITLE SHEET	0	03/29/2024	RV
	COUNTY: FREMONT GEOGRAPHIC COORDINATES:		G-002	GENERAL NOTES	0	03/29/2024	RV
	LATITUDE: 38.40615581		C-101	DETAILED SITE PLAN	0	03/29/2024	RV
	LONGITUDE: -105.26637542	ANTENNA MOUNTING PIPE(s)	C-201	TOWER ELEVATION	0	03/29/2024	RV
	GROUND ELEVATION: 5768' AMSL	GROUND WORK:	C-401	ANTENNA INFORMATION & SCHEDULE	0	03/29/2024	RV
	GROUND ELEVATION, 5700 AWGL	EXISTING T-MOBILE GROUND EQUIPMENT TO REMAIN	C-501	CONSTRUCTION DETAILS	0	03/29/2024	RV
-			E-501	GROUNDING DETAILS	0	03/29/2024	RV
		PROJECT NOTES	R-601	SUPPLEMENTAL	41		
	PROJECT TEAM	THE FACILITY IS UNMANNED.	R-602	MOUNT ANALYSIS - SUPPLEMENTAL			
UTILITY COMPANIES POWER COMPANY: T.B.D. PHONE: T.B.D. TELEPHONE COMPANY: T.B.D. PHONE: T.B.D. Know what's below, Call before you dig.	TOWER OWNER: AMERICAN TOWER 10 PRESIDENTIAL WAY WOBURN, MA 01801 ENGINEER: FULLERTON ENGINEERING CONSULTANTS, LLC 1100 E. WOODFIELD ROAD, SUITE 500 SCHAUMBURG, IL 60173 PROPERTY OWNER: LLOYD OLOMON 12868 CR 3 CANON CITY,CO 81212-0000	 A TECHNICIAN WILL VISIT THE SITE APPROXIMATELY ONCE A MONTH FOR ROUTINE INSPECTION AND MAINTENANCE. THE PROJECT WILL NOT RESULT IN ANY SIGNIFICANT LAND DISTURBANCE OR EFFECT OF STORM WATER DRAINAGE. NO SANITARY SEWER, POTABLE WATER OR TRASH DISPOSAL IS REQUIRED. HANDICAP ACCESS IS NOT REQUIRED. THE PROJECT DEPICTED IN THESE PLANS QUALIFIES AS AN ELIGIBLE FACILITIES REQUEST ENTITLED TO EXPEDITED REVIEW UNDER 47 U.S.C. § 1455(A) AS A MODIFICATION OF AN EXISTING WIRELESS TOWER THAT INVOLVES THE COLLOCATION, REMOVAL, AND/OR REPLACEMENT OF TRANSMISSION EQUIPMENT THAT IS NOT A SUBSTANTIAL CHANGE UNDER CFR § 1.61000 (B)(7). PROJECT LOCATION DIRECTIONS FROM CANON CITY, CO DEPART US-50 / W ROYAL GORGE BLVD TOWARD S 6TH ST 0.5 MI. TURN LEFT ONTO S 1ST ST 0.6 MI. ROAD NAME CHANGES TO TEMPLE CANYON RD 0.5 MI. KEEP RIGHT TO STAY ON TEMPLE CANYON RD 1.1 MI. ARRIVE AT TEMPLE CANYON RD					





REV.	DESCRIPTION	BY	DATE
<u> </u>	PRELIM	AH	03/21/24
∕₀	FINAL	RV	03/29/24
\triangle			
\triangle			
\triangle			

ATC SITE NUMBER: 370533 ATC SITE NAME:

CANON CITY

T-MOBILE SITE NAME:

DN04300B

SITE ADDRESS: 12868 CR 3 CANON CITY, CO 81212-0000

SEAL:



T. Mobile

ATC PROJ. #:	14752410_G0
CUST. ID:	DN04300B
CUST. #:	DN04300B

TITLE SHEET

SHEET NUMBER:

G-001

GENERAL CONSTRUCTION NOTES:

- OWNER FURNISHED MATERIALS, T-MOBILE "THE COMPANY" WILL PROVIDE AND THE CONTRACTOR WILL INSTALL
 - A. BTS EQUIPMENT FRAME (PLATFORM) AND ICEBRIDGE SHELTER (GROUND BUILD/CO-LOCATE ONLY)
 - AC/TELCO INTERFACE BOX (PPC)
 - C. ICE BRIDGE (CABLE TRAY WITH COVER) (GROUND BUILD/CO-LOCATE ONLY, GC TO FURNISH AND INSTALL FOR ROOFTOP INSTALLATION)
 - D. TOWERS, MONOPOLES
 - TOWER LIGHTING
 - GENERATORS & LIQUID PROPANE TANK
 - G. ANTENNA STANDARD BRACKETS, FRAMES AND PIPES FOR MOUNTING
 - ANTENNAS (INSTALLED BY OTHERS) TRANSMISSION LINE
 - TRANSMISSION LINE JUMPERS
 - TRANSMISSION LINE CONNECTORS WITH WEATHERPROOFING KITS
 - TRANSMISSION LINE GROUND KITS

 - HOISTING GRIPS
 - O. BTS EQUIPMENT
- THE CONTRACTOR IS RESPONSIBLE TO PROVIDE ALL OTHER MATERIALS FOR THE COMPLETE INSTALLATION OF THE SITE INCLUDING, BUT NOT LIMITED TO, SUCH MATERIALS AS FENCING, STRUCTURAL STEEL SUPPORTING SUB-FRAME FOR PLATFORM, ROOFING LABOR AND MATERIALS, GROUNDING RINGS, GROUNDING WIRES, COPPER-CLAD OR XIT CHEMICAL GROUND ROD(S), BUSS BARS, TRANSFORMERS AND DISCONNECT SWITCHES WHERE APPLICABLE, TEMPORARY FLECTRICAL POWER CONDUT, LANDSCAPING COMPOUND STONE, CRANES, CORE DRILLING, SLEEPERS AND RUBBER MATTING, REBAR, CONCRETE CAISSONS, PADS AND/OR AUGER MOUNTS, MISCELLANEOUS FASTENERS, CABLE TRAYS, NON-STANDARD ANTENNA FRAMES AND ALL OTHER MATERIAL AND LABOR REQUIRED TO COMPLETE THE JOB ACCORDING TO THE DRAWNINGS AND SPECIFICATIONS, IT IS THE POSITION OF T-MOBILE TO APPLY FOR PERMITTING AND CONTRACTOR RESPONSIBLE FOR PICKUP AND PAYMENT OF REQUIRED
- ALL WORK SHALL CONFORM TO ALL CURRENT APPLICABLE FEDERAL, STATE, AND LOCAL CODES, INCLUDING ANSI/EIA/TIA-222, AND COMPLY WITH ATC CONSTRUCTION
- CONTRACTOR SHALL CONTACT LOCAL 811 FOR IDENTIFICATION OF UNDERGROUND UTILITIES PRIOR TO START OF CONSTRUCTION.
- CONTRACTOR SHALL BE RESPONSIBLE FOR COORDINATING ALL REQUIRED
- ALL DIMENSIONS TO, OF, AND ON EXISTING BUILDINGS, DRAINAGE STRUCTURES, AND SITE IMPROVEMENTS SHALL BE VERIFIED IN FIELD BY CONTRACTOR WITH ALL DISCREPANCIES REPORTED TO THE ENGINEER.
- DO NOT CHANGE SIZE OR SPACING OF STRUCTURAL ELEMENTS.
- DETAILS SHOWN ARE TYPICAL; SIMILAR DETAILS APPLY TO SIMILAR CONDITIONS UNLESS
- THESE DRAWINGS DO NOT INCLUDE NECESSARY COMPONENTS FOR CONSTRUCTION SAFETY WHICH SHALL BE THE SOLE RESPONSIBILITY OF THE CONTRACTOR.
- CONTRACTOR SHALL BRACE STRUCTURES UNTIL ALL STRUCTURAL FLEMENTS NEEDED FOR STABILITY ARE INSTALLED. THESE ELEMENTS ARE AS FOLLOWS: LATERAL BRACING, 34.
- CONTRACTOR SHALL DETERMINE EXACT LOCATION OF EXISTING UTILITIES, GROUNDS DRAINS, DRAIN PIPES, VENTS, ETC. BEFORE COMMENCING WORK.
- INCORRECTLY FABRICATED, DAMAGED, OR OTHERWISE MISFITTING OR NONCONFORMING MATERIALS OR CONDITIONS SHALL BE REPORTED TO THE T-MOBILE REP PRIOR TO REMEDIAL OR CORRECTIVE ACTION, ANY SUCH REMEDIAL ACTION SHALL REQUIRE WRITTEN APPROVAL BY THE T-MOBILE REP PRIOR TO PROCEEDING.
- EACH CONTRACTOR SHALL COOPERATE WITH THE T-MOBILE REP, AND COORDINATE HIS WORK WITH THE WORK OF OTHERS.
- CONTRACTOR SHALL REPAIR ANY DAMAGE CAUSED BY CONSTRUCTION OF THIS PROJECT TO MATCH EXISTING PRE-CONSTRUCTION CONDITIONS TO THE SATISFACTION OF THE T-MOBILE CONSTRUCTION MANAGER.
- ALL CABLE/CONDUIT ENTRY/EXIT PORTS SHALL BE WEATHERPROOFED DURING INSTALLATION USING A SILICONE SEALANT.
- WHERE EXISTING CONDITIONS DO NOT MATCH THOSE SHOWN IN THIS PLAN SET, CONTRACTOR SHALL NOTIFY THE T-MOBILE REP AND ENGINEER OF RECORD
- CONTRACTOR SHALL ENSURE ALL SUBCONTRACTORS ARE PROVIDED WITH A COMPLETE AND CURRENT SET OF DRAWINGS AND SPECIFICATIONS FOR THIS PROJECT.
- CONTRACTOR SHALL REMOVE ALL RUBBISH AND DEBRIS FROM THE SITE AT THE END OF
- CONTRACTOR SHALL COORDINATE WORK SCHEDULE WITH AMERICAN TOWER CORPORATION (ATC) AND TAKE PRECAUTIONS TO MINIMIZE IMPACT AND DISRUPTION OF OTHER OCCUPANTS OF THE FACILITY.
- 20. CONTRACTOR SHALL FURNISH T-MOBILE AND AMERICAN TOWER CORPORATION (ATC) WITH A PDF MARKED UP AS-BUILT SET OF DRAWINGS UPON COMPLETION OF WOR
- PRIOR TO SUBMISSION OF BID, CONTRACTOR SHALL COORDINATE WITH T-MOBILE REP
 TO DETERMINE WHAT, IF ANY, ITEMS WILL BE PROVIDED. ALL ITEMS NOT PROVIDED
 SHALL BE PROVIDED AND INSTALLED BY THE CONTRACTOR. CONTRACTOR WILL INSTALL ALL ITEMS PROVIDED.

- 22. PRIOR TO SUBMISSION OF BID, CONTRACTOR SHALL COORDINATE WITH T-MOBILE REP TO DETERMINE IF ANY PERMITS WILL BE OBTAINED BY CONTRACTOR, ALL REQUIRED PERMITS NOT OBTAINED BY T-MOBILE MUST BE OBTAINED, AND PAID FOR, BY THE
- CONTRACTOR SHALL INSTALL ALL SITE SIGNAGE IN ACCORDANCE WITH T-MOBILE SPECIFICATIONS AND REQUIREMENTS.
- 24. CONTRACTOR SHALL SUBMIT ALL SHOP DRAWINGS TO T-MOBILE FOR REVIEW AND APPROVAL PRIOR TO FABRICATION.
- ALL EQUIPMENT SHALL BE INSTALLED ACCORDING TO MANUFACTURER'S 25. SPECIFICATIONS AND LOCATED ACCORDING TO T-MOBILE SPECIFICATIONS, AND AS
- THE CONTRACTOR SHALL SUPERVISE AND DIRECT THE PROJECT DESCRIBED HEREIN. THE CONTRACTOR SHALL BE SOLELY RESPONSIBLE FOR ALL THE CONSTRUCTION MEANS, METHODS, TECHNIQUES, SEQUENCES AND PROCEDURES AND FOR COORDINATING ALL PORTIONS OF THE WORK UNDER THE CONTRACT.
- 27. CONTRACTOR SHALL NOTIFY T-MOBILE REP A MINIMUM OF 48 HOURS IN ADVANCE OF POURING CONCRETE OR BACKFILLING ANY UNDERGROUND UTILITIES, FOUNDATIONS OR SEALING ANY WALL, FLOOR OR ROOF PENETRATIONS FOR ENGINEERING REVIEW AND
- WHEN THE PROJECT SCOPE REQUIRES THE USE OF THE SAFETY CLIMB. THE GENERAL CONTRACTOR SHALL ENSURE THE SAFETY CLIMB IS FREE OF OBSTRUCTIONS, NOT RUBBING ON OR TRAPPED BY ANY INSTALLED CUSTOMER EQUIPMENT, IS VISUALLY TAUT, MEETS MANUFACTURER INSTALLATION SPECIFICATIONS, AND IS FIRMLY SECURED AT ALL CABLE GUIDE LOCATIONS UPON PROJECT COMPLETION.
- COMPLETION OF PROJECT SHALL NOT OBSTRUCT, TRAP, LOOSEN, OR OTHERWISE CAUSE FAILURE TO MEET MANUFACTURER INSTALLATION REQUIREMENTS FOR THE SAFETY CLIMB.
- CONTRACTOR SHALL BE RESPONSIBLE FOR SITE SAFETY INCLUDING COMPLIANCE WITH ALL APPLICABLE OSHA STANDARDS AND RECOMMENDATIONS AND SHALL PROVIDE ALL NECESSARY SAFETY DEVICES INCLUDING PPE AND PPM AND CONSTRUCTION DEVICES SUCH AS WELDING AND FIRE PREVENTION, TEMPORARY SHORING, SCAFFOLDING, TRENCH BOXES/SLOPING, BARRIERS, ETC.
- THE CONTRACTOR SHALL PROTECT AT HIS OWN EXPENSE, ALL EXISTING FACILITIES AND SUCH OF HIS NEW WORK LIABLE TO INJURY DURING THE CONSTRUCTION PERIOD. ANY 31. DAMAGE CAUSED BY NEGLECT ON THE PART OF THIS CONTRACTOR OR HIS DAMAGE CAUSED BY NEGLECT ON THE PART OF THIS CONTRACTOR OR HIS REPRESENTATIVES, OR BY THE ELEMENTS DUE TO NEGLECT ON THE PART OF THIS CONTRACTOR OR HIS REPRESENTATIVES, EITHER TO THE EXISTING WORK, OR TO HIS WORK OR THE WORK OF ANY OTHER CONTRACTOR, SHALL BE REPAIRED AT HIS EXPENSE TO THE OWNER'S SATISFACTION.
- ALL WORK SHALL BE INSTALLED IN A FIRST CLASS, NEAT AND WORKMANLIKE MANNER BY MECHANICS SKILLED IN THE TRADE INVOLVED. THE QUALITY OF WORKMANSHIP SHALL BE SUBJECT TO THE APPROVAL OF THE T-MOBILE REP, ANY WORK FOUND BY THE T-MOBILE REP TO BE OF INFERIOR QUALITY AND/OR WORKMANSHIP SHALL BE REPLACED AND/OR REWORKED AT CONTRACTOR EXPENSE UNTIL APPROVAL I
- IN ORDER TO ESTABLISH STANDARDS OF QUALITY AND PERFORMANCE, ALL TYPES OF MATERIALS LISTED HEREINAFTER BY MANUFACTURER'S NAMES AND/OR MANUFACTURER'S CATALOG NUMBER SHALL BE PROVIDED BY THESE MANUFACTURERS
- T-MOBILE FURNISHED EQUIPMENT SHALL BE PICKED-UP AT THE T-MOBILE WAREHOUSE, NO LATER THAN 48HR AFTER BEING NOTIFIED INSURED, STORED, UNCRATE, PROTECTED AND INSTALLED BY THE CONTRACTOR WITH ALL APPURTENANCES REQUIRED TO PLACE THE EQUIPMENT IN OPERATION, READY FOR USE. THE CONTRACTOR SHALL BE RESPONSIBLE FOR THE EQUIPMENT AFTER PICKING IT UP.
- T-MOBILE OR HIS ARCHITECT/ENGINEER RESERVES THE RIGHT TO REJECT ANY EQUIPMENT OR MATERIALS WHICH, IN HIS OWN OPINION ARE NOT IN COMPLIANCE WITH THE CONTRACT DOCUMENTS, EITHER BEFORE OR AFTER INSTALLATION AND THE THE CONTRACT DOCUMENTS, ETHER BOTAL OR AT HER INSTALLATION AND THE EQUIPMENT SHALL BE REPLACED WITH EQUIPMENT CONFORMING TO THE REQUIREMENTS OF THE CONTRACT DOCUMENTS BY THE CONTRACTOR AT NO COST TO T-MOBILE OR THEIR ARCHITECT/ENGINEER.

SPECIAL CONSTRUCTION

- 1. WORK INCLUDED:
 - A. ANTENNA AND COAXIAL/HYBRID CABLES ARE FURNISHED BY T-MOBILE UNDER A SEPARATE CONTRACT, THE CONTRACTOR SHALL ASSIST ANTENNA INSTALLATION CONTRACTOR IN TERMS OF COORDINATION AND SITE ACCESS. ERECTION SUBCONTRACTOR SHALL BE RESPONSIBLE FOR THE PROTECTION OF
 - B. INSTALL ANTENNAS AS INDICATED ON DRAWINGS AND T-MOBILE
 - C. INSTALL GALVANIZED STEEL ANTENNA MOUNTS AS INDICATED ON DRAWINGS.
 - D. INSTALL FURNISHED GALVANIZED STEEL OR ALUMINUM WAVEGUIDE
 - INSTALL COAXIAL/HYBRID CABLES AND TERMINATING BETWEEN ANTENNAS AND EQUIPMENT PER MANUFACTURER'S RECOMMENDATIONS. WEATHERPROOF ALL CONNECTIONS BETWEEN THE ANTENNA AND EQUIPMENT PER MANUFACTURER'S REQUIREMENTS. TERMINATE ALL COAXIAL/HYBRID CABLE THREE (3) FEET IN EXCESS OF ENTRY PORT LOCATION UNLESS OTHERWISE STATED.
- ANTENNA AND COAXIAL/HYBRID CABLE GROUNDING:
 - A. ALL EXTERIOR #6 GREEN GROUND WIRE "DAISY CHAIN" CONNECTIONS ARE TO BE WEATHER SEALED WITH RFS CONNECTORS/SPLICE WEATHERPROOFING KIT #221213 OR EQUAL

B. ALL COAXIAL/HYBRID CABLE GROUNDING KITS ARE TO BE INSTALLED ON STRAIGHT RUNS OF COAXIAL/HYBRID CABLE (NOT WITHIN BENDS

> ALL DISCREPANCIES FROM WHAT IS SHOWN ON THESE CONSTRUCTION DRAWINGS SHALL BE COMMUNICATED TO ATC ENGINEERING IMMEDIATELY FOR CORRECTION OR RE-DESIGN. FAILURE TO COMMUNICATE DIRECTLY WITH ATC ENGINEERING OR ANY CHANGES FROM THE DESIGN CONDUCTED WITHOUT PRIOR APPROVAL FROM ATC ENGINEERING SHALL BE THE SOLE RESPONSIBILITY OF THE GENERAL CONTRACTOR.





1 100 E. WOODFIELD ROAD, SUITE 500 SCHAUMBURG, ILLINOIS 60173 TEL: 847-908-8400

RFV DESCRIPTION BY DATE **PRELIM** AH 03/21/24 RV 03/29/24

> ATC SITE NUMBER: 370533 ATC SITE NAME:

CANON CITY

T-MOBILE SITE NAME:

DN04300B

SITE ADDRESS: 12868 CR 3 CANON CITY, CO 81212-0000

SEAL:



T. Mobile

ATC PROJ. #: 14752410 G0 CUST. ID: DN04300B CUST. #: DN04300B

GENERAL NOTES

SHEET NUMBER G-002


SITE PLAN NOTES:

- 1, THIS SITE PLAN REPRESENTS THE BEST PRESENT KNOWLEDGE AVAILABLE TO THE ENGINEER AT THE TIME OF THIS DESIGN. THE CONTRACTOR SHALL VISIT THE SITE PRIOR TO CONSTRUCTION AND VERIFY ALL EXISTING CONDITIONS RELATED TO THE SCOPE OF WORK FOR THIS PROJECT.
- 2. ICE BRIDGE, CABLE LADDER, COAX PORT, AND COAX CABLE ARE SHOWN FOR REFERENCE ONLY. CONTRACTOR SHALL CONFIRM THE EXACT LOCATION OF ALL PROPOSED AND EXISTING EQUIPMENT AND STRUCTURES DEPICTED ON THIS PLAN. BEFORE UTILIZING EXISTING CABLE SUPPORTS, COAX PORTS, INSTALLING NEW PORTS OR ANY OTHER EQUIPMENT, CONTRACTOR SHALL VERIFY ALL ASPECTS OF THE COMPONENTS MEET THE ATC SPECIFICATIONS.
- NO ELECTRICAL SCOPE IS INCLUDED IN THIS PROJECT.

	LEGEND
\otimes	GROUNDING TEST WELL
ATS	AUTOMATIC TRANSFER SWITCH
В	BOLLARD
CSC	CELL SITE CABINET
D	DISCONNECT
Ę	ELECTRICAL
F	FIBER
GEN	GENERATOR
G	GENERATOR RECEPTACLE
HH, V	HAND HOLE, VAULT
IB	ICE BRIDGE
K	KENTROX BOX
LC	LIGHTING CONTROL
M	METER
PB	PULL BOX
PP	POWER POLE
Т	TELCO
TRN	TRANSFORMER
	CHAINLINK FENCE

PROPOSED CABLE NOTES:

- 1. ESTIMATED LENGTH OF PROPOSED CABLE IS 205'. ESTIMATED LENGTH OF CABLE WAS PROVIDED BY CUSTOMER OR CALCULATED BY ADDING THE RAD CENTER AND THE DISTANCE FROM THE SHELTER ENTRY PLATE TO THE TOWER (ALONG THE ICE BRIDGE) AND A SAFETY FACTOR MEASUREMENT OF 15% (OF THE TWO PREVIOUS VALUES), CDS DEFER TO GREATEST CABLE LENGTH.
- 2. ROUTE PROPOSED CABLES ALONG SAME PATH AS EXISTING CABLES AND IN ACCORDANCE WITH STRUCTURAL ANALYSIS. WHERE POSSIBLE UTILIZE EXISTING CABLE SUPPORT STRUCTURES AS PROVIDED FOR CARRIER TO ADEQUATELY SECURE CABLES, USING EITHER APPROPRIATELY SIZED STAINLESS STEEL SNAP-INS OR MOUNTING HARDWARE AND BRACKETS AS SPECIFIED BY CABLE MANUFACTURER. OTHERWISE, ATTACH CABLES TO HORIZONTAL OR DIAGONAL TOWER MEMBERS USING PROPOSED STAINLESS STEEL ADAPTERS (DO NOT ATTACH TO TOWER LEG).

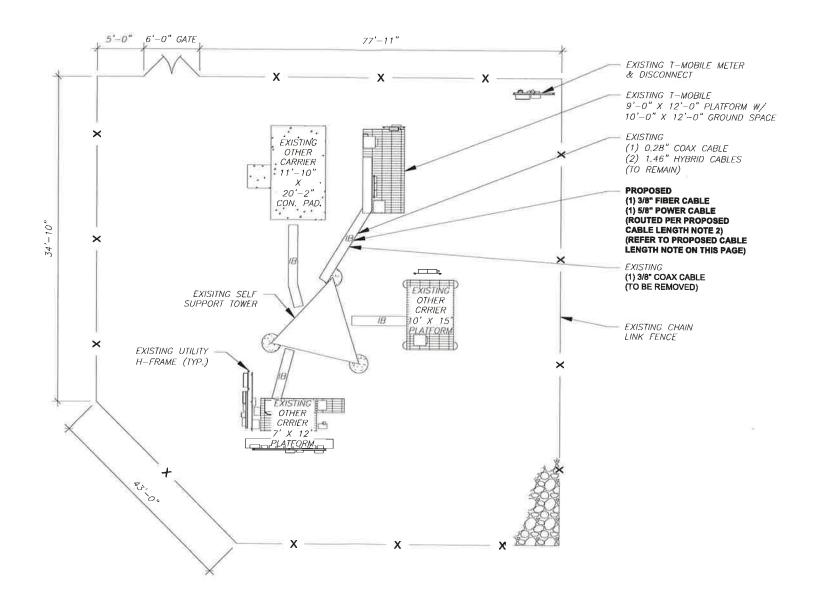

DETAILED SITE PLAN

GRAPHIC SCALE

(IN FEET)

1 UNIT = 20 FEET





1100 E, WOODFIELD ROAD, SUITE 500 SCHAUMBURG, ILLINOIS 60173 TEL: 847-908-8400

REV.	DESCRIPTION	BY	DATE
<u>A</u>	PRELIM	AH	03/21/24
∕₀\	FINAL	RV	03/29/24
\wedge			
\wedge			
$\overline{\wedge}$			

ATC SITE NUMBER: 370533
ATC SITE NAME:

CANON CITY

T-MOBILE SITE NAME:

DN04300B

SITE ADDRESS: 12868 CR 3 CANON CITY, CO 81212-0000

SEAL:




T. Mobile

ATC PROJ. #: 14752410_G0
CUST. ID: DN04300B
CUST. #: DN04300B

DETAILED SITE PLAN

SHEET NUMBER:

C-101

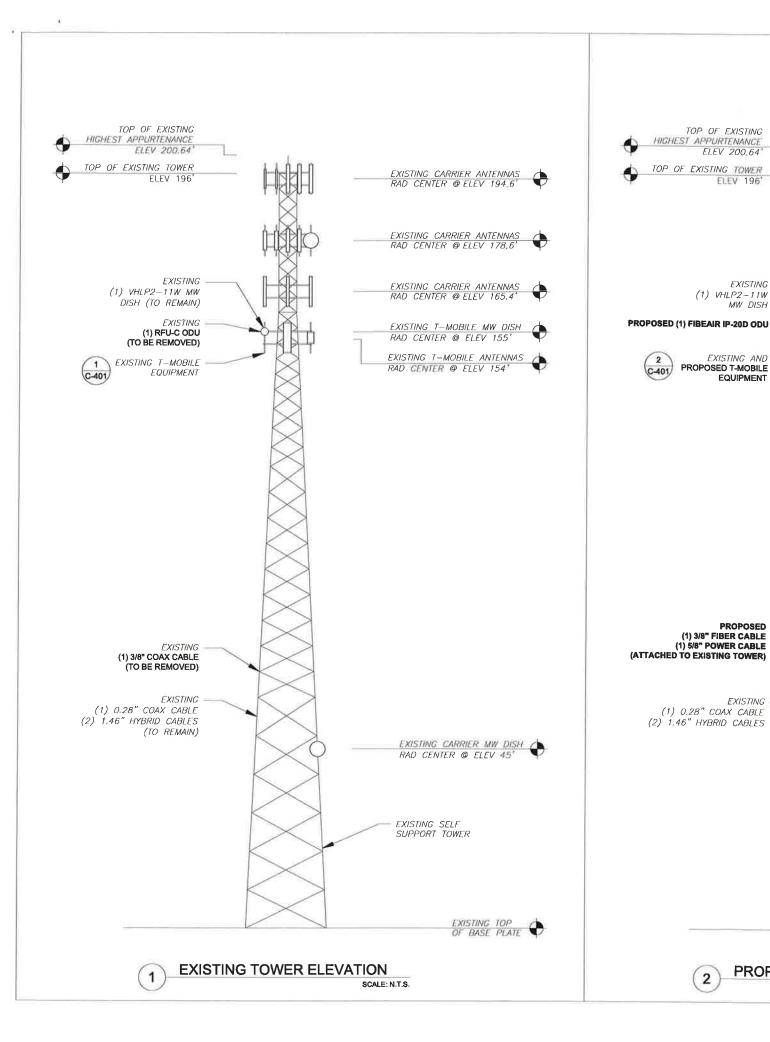

PER MOUNT ANALYSIS COMPLETED BY ATC, DATED 03/11/2024, THE EXISTING MOUNT CAN ADEQUATELY SUPPORT THE PROPOSED LOADING.

ATC HAS COMPLETED THE TOWER ANALYSIS ON 03/13/2024 AND THE TOWER CAN ADEQUATELY SUPPORT THE PROPOSED

EXISTING CARRIER ANTENNAS RAD CENTER @ ELEV 178.6

EXISTING CARRIER ANTENNAS RAD CENTER @ ELEV. 165.4'

RAD CENTER @ ELEV 155"

RAD CENTER @ ELEV 154'

EXISTING T-MOBILE MW DISH

EXISTING T-MOBILE ANTENNAS





I 100 E. WOODFIELD ROAD, SUITE 500 SCHAUMBURG, ILLINOIS 60173 TEL: 847-908-8400

REV. DESCRIPTION BY DATE PRELIM AH 03/21/24 RV 03/29/24 ATC SITE NUMBER:

> 370533 ATC SITE NAME:

CANON CITY

T-MOBILE SITE NAME:

DN04300B

SITE ADDRESS: 12868 CR 3 CANON CITY, CO 81212-0000

SEAL



T - Mobile

ATC PROJ. #: 14752410_G0 CUST. ID: DN04300B CUST. #: DN04300B

TOWER ELEVATION

SHEET NUMBER: REVISION:

0

C-201



EXISTING SELF

SUPPORT TOWER

TOP OF EXISTING

ELEV 200.64

ELEV 196

EXISTING

MW DISH

EQUIPMENT

PROPOSED

EXISTING

(1) 3/8" FIBER CABLE (1) 5/8" POWER CABLE

(1) 0.28" COAX CABLE

(1) VHLP2-11W

EXISTING AND PROPOSED T-MOBILE

HIGHEST APPURTENANCE

TOP OF EXISTING TOWER

TOWER NOTE:

1. IT IS THE CONTRACTOR'S RESPONSIBILITY TO CONFIRM WITH THE PROJECT MANAGER THAT RAD CENTER @ ELEV 45'


THEY HAVE THE MOST RECENT VERSION OF THE STRUCTURAL ANALYSIS BEFORE COMMENCING WORK. EXISTING AND PROPOSED TOWER APPURTENANCES, MOUNTS, AND ANTENNAS ARE APPURTENANCES, MOUNTS, AND ANTENNAS ARE SHOWN BASED ON THE STRUCTURAL ANALYSIS. 2. WHERE APPLICABLE, ALL NEW ANTENNAS, EQUIPMENT, MOUNTS, CABLING, ETC. SHALL BE PAINTED/SOCKED TO MATCH EXISTING EQUIPMENT IN ACCORDANCE WITH FAA, JURISDICTION, AND/OR OTHER LOCAL REQUIREMENTS. 3. ROUTE PROPOSED CABLES ALONG SAME PATH AS EXISTING CABLES AND IN ACCORDANCE WITH STRUCTURAL ANALYSIS. WHERE POSSIBLE UTILIZE EXISTING CABLE SUPPORT STRUCTURES AS PROVIDED FOR CARRIER TO ADEQUATELY SECURE CABLES, USING EITHER APPROPRIATELY SIZED STAINLESS STEEL SNAP-INS OR MOUNTING HARDWARE AND BRACKETS AS SPECIFIED BY CABLE MANUFACTURER, OTHERWISE, ATTACH OF BASE PLATE


CABLES TO HORZONTAL OR DIAGONAL TOWER MEMBERS USING PROPOSED STAINLESS STEEL

ADAPTERS (DO NOT ATTACH TO TOWER LEG). TOWER ELEVATION DEPICTION MAY NOT REFLECT

ALL EQUIPMENT INCLUDED IN STRUCTURAL ANALYSIS. REFER TO STRUCTURAL ANALYSIS FOR

FULL TOWER LOADING.

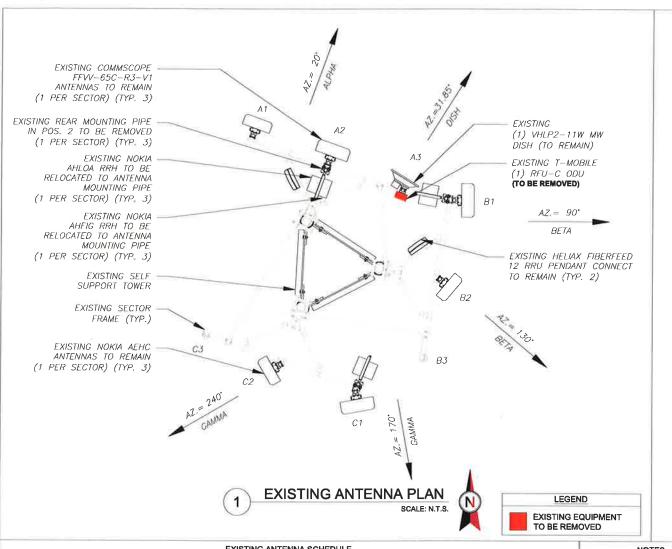

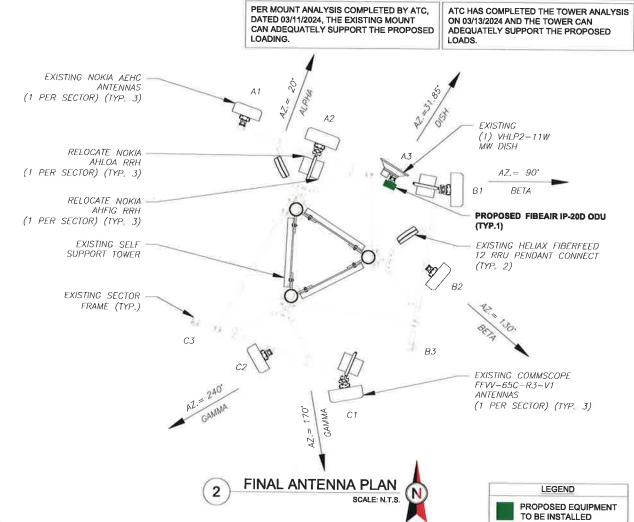

					EXISTING ANTENNA SC	HEDULE				NOTES					FIN	IAL ANTENNA SCHEDUL	.E			
L	CATIO	N		AN	ITENNA SUMMARY			NON ANTENNA SUMM	IARY	GC TO VERIFY THE FINAL RFDS MATCHES THE FINAL	LO	CATIO	N		AN'	TENNA SUMMARY			NON ANTENNA SUM	MARY
SECTOR	RAD	AZ	POS	ANTENNA	BAND	MECH/ELEC D-TILT	STATUS	ADDITIONAL TOWER MOUNTED EQUIPMENT	STATUS	CONSTRUCTION DRAWINGS. GC TO NOTIFY ATC PM OF ANY	ECTOR	RAD	AZ	POS	ANTENNA	BAND	MECH/ELEC D-TILT	STATUS		OTATUO
			A1	AEHC	N2500/L2500	0/0	RMN	-	77/	DISCREPANCY PRIOR TO INSTALLING THE EQUIPMENT.				A1	AFHC .				MOONTED EQUIPMENT	-
	154"	20'	4.0	FD44 650 B7 14	L700,L600,N600,L1	0.70		AHLOA	REL	2. GC TO CAP ALL UNUSED		154'	20.	AI	AEHC	N2500/L2500	0/0	RMN		
ALPHA	_		A2	FFVV-65C-R3-V1	900,G1900,L2100	0/0	RMN	AHFIG	REL		LPHA	134	20	A2	FFW-65C-R3-V1	L700,L600,N600,L1 900,G1900,L2100	0/0	RMN	AHLOA AHFIG	REL REL
	155'	31.85	A3	VHLP2-11W MW DISH	L700,L600,N600,L1 900,G1900,L2100	0/0	RMN	RFU-C ODU	RMV	PROPOSED EQUIP DOES NOT CAUSE TOWER CONFLICTS NOR IMPEDE TOWER CLIMBING		155'	31.85*	А3	VHLP2-11W MW DISH	L700,L600,N600,L1 900,G1900,L2100	0/0	RMN	FIBEAIR IP-20D ODU	ADD
		90*	B1	FFVV-65C-R3-V1	L700,L600,N600,L1 900,G1900,L2100	0/0	RMN	AHLOA AHFIG	REL REL	PEGS.			90'	B1	FFW-65C-R3-V1	L700,L600,N600,L1	0/0	RMN	AHLOA	REL
BETA	1515	170*	00	15110	N0500 // 0500	0.40	5,44			STATUS ABBREVIATIONS	1	- 11			7177 300 118 77	900,G1900,L2100	070	TAIVITY	AHFIG	REL
BEIA	154*	130*	B2	AEHC	N2500/L2500	0/0	RMN	-		KMV: TO BE REMOVED	BETA	154'	130°	B2	AEHC	N2500/L2500	0/0	RMN	-	-
		100	B3	-	340	-	-	_	-	RMN: TO REMAIN REL: TO BE RELOCATED			-	В3						_
					L700,L600,N600,L1			AHLOA	REL	ADD: TO BE ADDED				100			1000	-		366
		170°	C1	FFVV-65C-R3-V1	900,G1900,L2100	0/0	RMN	AHFIG	REL				170°	C1	FFVV-65C-R3-V1	L700,L600,N600,L1 900,G1900,L2100	0/0	RMN	AHLOA	REL
CAMMA	1540	240		AFUE	N2500 (12500	0.70	0.44			CABLE LENGTHS FOR JUMPERS						900,61900,12100			AHFIG	REL
GAMMA	134	240	C2	AEHC	N2500/L2500	0/0	RMN			JUNCTION BOX TO RRU: 15'	AMMA	154'	240°	C2	AEHC	N2500/L2500	0/0	RMN	-	
		N=	C3		=1	100	124		1	RRU TO ANTENNA: 10'		- 1		-						
														C3		-	-	-	-	

EXISTING FIBER DISTRIBUTION /	OVP BOX	EXISTING CABLING SUMMARY					
MODEL NUMBER	STATUS	HYBRID	COAX	STATUS			
(2) HELIAX FIBERFEED 12 RRU PENDANT CONNECTS	RMN	(2) 1.46"	(1) 0.28"	RMN			
=	-	e e	(1) 3/8"	RMV			

3 EQUIPMENT SCHEDULES

FINAL FIBER DISTRIBUTION/O	FINAL CABLING SUMMARY							
MODEL NUMBER	STATUS	FIBER	POWER	HYBRID	COAX	STATUS		
(2) HELIAX FIBERFEED 12 RRU PENDANT CONNECTS	RMN		•	(2) 1.46"	(1) 0.28"	RMN		
8	28	(1) 3/8"	(1) 5/8"			ADD		





1100 E. WOODFIELD ROAD, SUITE 500 SCHAUMBURG, ILLINOIS 60173 TEL: 847-908-8400 www.fullerton-us.com

Â	PRELIM	AH	
\wedge		АП	03/21/24
/0\	FINAL	RV	03/29/24
\wedge			
\wedge			

ATC SITE NUMBER: 370533
ATC SITE NAME:

CANON CITY

T-MOBILE SITE NAME:

DN04300B

SITE ADDRESS: 12868 CR 3 CANON CITY, CO 81212-0000

SEAL:




T · Mobile

ATC PROJ. #:	14752410_G0	
CUST. ID:	DN04300B	
CUST. #:	DN04300B	

ANTENNA INFORMATION & SCHEDULE

SHEET NUMBER:	REVISION
C-401	0

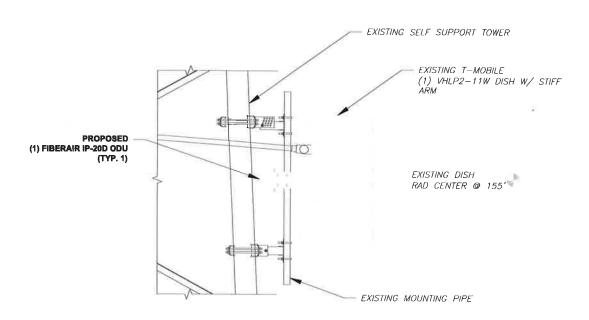

PROPOSED ODU MOUNTING DETAIL SCALE: N.T.S.





1100 E. WOODFIELD ROAD, SUITE 500 SCHAUMBURG, ILLINOIS 60173 TEL: 847-908-8400 www.fullerton-us.com

REV.	DESCRIPTION	BY	DATE
A	PRELIM	AH	03/21/24
<u>^</u>	FINAL	RV	03/29/24
\triangle			
\wedge			
\wedge			

ATC SITE NUMBER: 370533 ATC SITE NAME:


CANON CITY

T-MOBILE SITE NAME:

DN04300B

SITE ADDRESS: 12868 CR 3 CANON CITY, CO 81212-0000

SEAL:

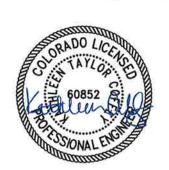


T. Mobile

ATC PROJ. #:	14752410_G0	
CUST. ID:	DN04300B	
CUST. #:	DN04300B	

SUPPLEMENTAL

SHEET NUMBER: REVISION: C-501

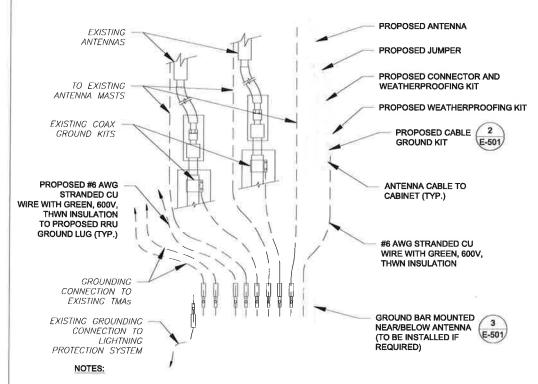

- THIS DETAIL IS INTENDED TO SHOW THE GENERAL GROUNDING REQUIREMENTS. SLIGHT ADJUSTMENTS MAY BE REQUIRED BASED ON EXISTING SITE CONDITIONS. THE CONTRACTOR SHALL MAKE FIELD ADJUSTMENTS AS NEEDED AND INFORM THE CONSTRUCTION MANAGER OF ANY CONFLICTS.
- SITE GROUNDING SHALL COMPLY WITH T-MOBILE GROUNDING STANDARDS, LATEST EDITION, AND COMPLY WITH T-MOBILE GROUNDING CHECKLIST, LATEST VERSION. WHEN NATIONAL AND LOCAL GROUNDING CODES ARE MORE STRINGENT THEY SHALL GOVERN.
 - TYPICAL ANTENNA GROUNDING DIAGRAM

GROUNDING KIT PER CABLE
MANUFACTURER'S RECOMMENDATIONS
(ANDREW OR APPROVED EQUAL)

#6 AWG STRANDED COPPER GROUND
WIRE (GROUNDED TO GROUND BAR)

TO GROUND BAR


GROUND KIT NOTES:

 DO NOT INSTALL CABLE GROUND KIT AT A BEND AND ALWAYS DIRECT GROUND WIRE DOWN TO GROUND BAR.

TO ANTENNA

CONTRACTOR SHALL PROVIDE WEATHERPROOFING KIT (ANDREW PART NUMBER 221213) AND INSTALL/TAPE PER MANUFACTURER'S SPECIFICATIONS.

CABLE GROUND KIT CONNECTION DETAIL
SCALE: N.T.S

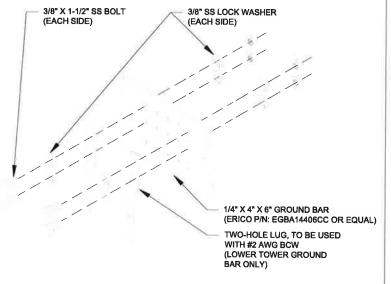

GROUND BAR NOTES:

- GROUND BAR KITS COME WITH ALL HARDWARE, NUTS, BOLTS, WASHERS, ETC. EXCEPT THE STRUCTURAL MOUNTING MEMBER(S).
- 2. GROUND BAR TO BE BONDED DIRECTLY TO TOWER.







1100 E. WOODFIELD ROAD, SUITE 500 SCHAUMBURG, ILLINOIS 60173 TEL: 847-908-8400

REV.	DESCRIPTION	BY	DATE
A	PRELIM	AH	03/18/24
<u></u>	FINAL	RV	03/29/24
\wedge			
\wedge			
\wedge			

ATC SITE NUMBER: 370533

ATC SITE NAME:

CANON CITY

T-MOBILE SITE NAME: DN04300B

SITE ADDRESS: 12868 CR 3

CANON CITY, CO 81212-0000

SEAL:



T · Mobile

ATC PROJ. #: 14752410_G0
CUST. ID: DN04300B
CUST. #: DN04300B

GROUNDING DETAILS

SHEET NUMBER:

E-501

High-availability, split-mount, modular multicore aggregation node

Designed uniquely for the North American market, FibeAir IP-20A is a highly-flexible aggregation node that delivers multi-Gbps radio capacity at a very large scale. Now available with multicore technology and new radio units, IP-20A features high modularity and flexibility and supports up to 8 radio links with an exceptionally wide variety of line interfaces via pluggable modules, in a wide range of network topologies - making it the preferred node for your transport network's aggregation sites.

The FibeAir IP-20A operates within the entire microwave and millimeter-wave spectrum, offering high spectral efficiency across licensed and license-exempt frequency bands (4-86 GHz). It also supports all high-speed data interfaces (10G/1G/FE) and a wide variety of TDM interfaces (DS1, OC-3); operates with a wide variety of multicore, standard and high power radios; and accommodates various network configurations including 1x 8+0, 4x 2+0, and 8x 1+0.

For exact feature availability, contact your Ceragon representative. In case of discrepancy between this Datasheet and the Technical Description for the product, the Technical Description prevails.

Assembly options

1RU Chassis - 5x Universal slots;

2RU Chassis -10x Universal slots

Radio

Supported Frequency Range

Standard Power: 6-42 GHz, 71-76 GHz, 81-86 GHz

Supported RFUs

RFU-D - High-capacity MultiCore radio

RFU-D-HP - High-capacity, high-power MultiCore radio

RFU-E - High capacity E-band radio

RFU-C - High-capacity radio

1500HP/RFU-HP - High-capacity, high-power radio

N+0 (up to N=8), 1x 8+0, 2x 4+0, 4x 2+0, 8x 1+0, 1+1, 2+2

Split Mount (Standard Power, High Power)

All Indoor (High Power)

Multi-Carrier Adaptive Bandwidth Control (up to 8+0) Protection and Diversity: HSB, SD (BBC and BBS)

Channel bandwidth:

- . E-Band: up to 500 MHz

Note: 112 channels are planned for future

Multiband (with IP-50E/IP-20E)

Advanced Space Diversity (ASD)*

Field Replaceable Diplexers/ Field Replaceable Channel Filters

Ethernet

Ethernet Interfaces

1RU/2RU Traffic Interfaces - Up to 10 x 1000Base-T (RU-45) or 1000base-X (SFP)

Up to 2 x 10Gbase-X (SFP+)

Management Interfaces - 2 x 10/100 Base-T (RJ-45)

SFP Types - Optical 1000Base-LX (1310 nm) or SX (850 nm)

Ethernet Features

MTU - 9600 Bytes

Quality of Service

- Multiple Classification criteria (VLAN ID, P-bits, IPv4 DSCP, IPv6 TC, MPLS EXP)
- 8 priority queues per port
- Deep buffering (configurable up to 64 Mbit per queue)
- WRED
- P-bit marking/remarking

4K VLANS

VLAN add/remove

MSTP, ERP (ITU-T G.8032)

Frame Cut Through - controlled latency and PDV for delay sensitive applications

Header DeDuplication - Capacity boosting by eliminating inefficiency in all layers (L2, MPLS, L3, L4, Tunneling - GTP for LTE, GRE)

Y.1731 Ethernet OAM

Y.1731 Ethernet Bandwidth Notification (ETH-BN)

IP-20A 1RU CHASSIS



IP-20A 2RU CHASSIS

Modules

Product Images

IDU

RADIO MODEM CARDS (RMCs)

ETHERNET LIC WITH 1 COMBO AND 3

ELECTRICAL OR OPTICAL INTERFACES

RADIO INTERFACE CARDS (RICS)

TRAFFIC CONTROL CARDS (TCCs)







TDM LICs

ETHERNET LIC WITH A SINGLE 10G OPTICAL INTERFACE





Radio Units











1500HP/RFU-HP

BY REQUEST OF CUSTOMER WITHOUT EDIT.

RFU-A



RFU-C





SHEET NUMBER: NOTE: THIS SHEET CREATED BY OTHERS AND PROVIDED

SUPPLEMENTAL

R-601

REVISION:

Note:

General

Redundant TCC slots (2RU chassis only)

High Power: 4-11 GHz

RFU-5 - High-capacity radio

RFU-A - High-capacity, high-power radio

Typical Radio Configurations

Radio Features

High spectral utilization: BPSK to 4096 QAM w/ACM

4-42 GHz: up to 112 MHz

Planned for future release.



Mount Analysis Report

ATC Asset Name

: Canon City

ATC Asset Number

370533

Engineering Number

: 14752410_C8_01

Mount Elevation

: 152 ft

Proposed Carrier

: T-Mobile

Carrier Site Name

: DN04300B

Carrier Site Number

: DN04300B

Site Location

12868 Cr 3

CANON CITY, CO 81212-0000

38.406156, -105.266375

County

: Fremont

Date

: March 11, 2024

Max Usage

Analysis Result

: Contingent Pass

Prepared By: Aviskar Ghansam Structural Engineer I

Rushan Ghansam

Bryan Lanier Lanker Date 2024/03.13 21:35/24



ATC Tower Services, LLC - 1 Fenton Main, Suite 300 - Cary, NC 27511 - 919,468,0112 Office - 919,466,5414 Fax - www.americastower.com



Eng. Number 14752410 C8 01 March 11, 2024 Page 3

Introduction

The purpose of this report is to summarize results of the mount analysis performed for T-Mobile at 152 ft.

Supporting Documents

Previous Analysis:	ATC Project #13743168_C8_01 , dated February 17, 2024	
Radio Frequency Data Sheet:	RFDS ID #DN04300B, dated February 28, 2024	
Reference Photos:	Site photos from 2023	

<u>Analysis</u>

This mount was analyzed using American Tower Corporation's Mount Analysis Program and RISA-3D

Basic Wind Speed:	105 mph (3-Second Gust)
Basic Wind Speed w/ ice:	50 mph (3-Second Gust) w/ 0.25" radial ice concurrent
Codes:	ANSI/TIA-222-H
Exposure Category:	C
Risk Category:	II II
Topographic Factor Procedure:	Method 2
Feature:	Flat
Crest Height (H):	0 ft
Crest Length (L):	0 ft
Spectral Response:	Ss = 0.262, S1 = 0.072
Site Class:	D - Stiff Soil - Default
Live Loads:	Lm = 500 lbs, Lv = 250 lbs

Conclusion

Based on the analysis results, the antenna mount meets the requirements per the applicable codes listed above provided the modifications listed below are completed:

- Remove Rear Mount Pipe(s) A2 and attach RRU's directly to mount pipe in which the panel is
- A structural failure was addressed with the noted contingencies. The controlling member was a Horizontal with a usage of 200%.

If you have any questions or require additional information, please reach out to your American Tower contact. If you do not have an American Tower contact and have an Engineering question, please contact MountAnalysis@americantower.com. Please include the American Tower site name, site number, and engineering number in the subject line for any questions.

ATC Tower Services, LLC = 1 Fenton Main, Suite 300 - Cary, MC 27511 - 519.468,0112 Office = 919.466,9414 Fax + www.americantower.com

NOTE: THIS SHEET WAS CREATED BY OTHERS AND PROVIDED AT THE REQUEST OF THE CUSTOMER WITHOUT EDIT. PLEASE REFERENCE THE MOUNT ANALYSIS REPORT FOR COMPLETE MOUNT ANALYSIS CALCULATIONS AND DETAILS. SUPPLEMENTAL PAGES INCLUDED IN THE

CONSTRUCTION DRAWINGS ARE FOR REFERENCE ONLY. GENERAL CONTRACTOR IS TO VERYIFY THEY HAVE THE MOST RECENT MOUNT ANALYSIS PRIOR TO CONTRUCTION.

SUPPLEMENTAL

SHEET NUMBER: R-602